Council Meeting Date: March 15, 2021 Agenda Item: 7(f)

CITY COUNCIL AGENDA ITEM

CITY OF SHORELINE, WASHINGTON

AGENDA TITLE: Authorize the City Manager to Execute an Agreement with Sound

Transit for the Ridgecrest Park Retaining Wall Betterment as Part

Public Hearing

of the Lynnwood Link Extension Project

Public Works DEPARTMENT:

City Manager's Office

PRESENTED BY: Tricia Juhnke, City Engineer

Juniper Nammi, Light Rail Project Manager

ACTION: Ordinance Resolution X Motion Discussion

PROBLEM/ISSUE STATEMENT:

The "Trail Along the Rail" (Trail) is included in the City's approved 2021-2026 Capital Improvement Plan. The Trail project is intended to provide a shared use path aligned roughly parallel to Sound Transit's Lynnwood Link Extension light rail project (LLE Project) between NE 145th Street and the NE 195th Street Pedestrian Bridge.

Sound Transit is currently constructing the LLE Project which includes segments of a shared use path that will eventually become part of the Trail. However, with necessary cost reductions to the LLE Project, construction of path segments through Ridgecrest Park have been removed by Sound Transit.

Since construction of the Trail's segment through Ridgecrest Park would become difficult, if not impossible, to construct after completion of the LLE Project, in mid-2020, City staff began discussing with Sound Transit the opportunity to modify its design and construct a wall adjacent to Ridgecrest Park that would be utilized in the future for construction of the Trail by the City. The proposed Ridgecrest Park Retaining Wall Betterment Agreement (Attachment A) defines the terms and conditions of this modification.

RESOURCE/FINANCIAL IMPACT:

The 2021-2026 Capital Improvement Plan (CIP) includes the Trail Along the Rail Project. A summary of the project expenditures and budget for the Ridgecrest Park Retaining Wall project is shown below:

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Expenses							
City Direct Expenses	(\$10,000)						
Design and Cost Estimating		(\$77,563)					
Betterment Agreement (ST)							
Construction Costs	(\$590,000)						
ST Costs (9.3%)	(\$54,640)						
Contingency	(\$59,000)						
Permitting		(\$2,400)					
7	otal Expenses	(\$793,603)					
		-					
Revenue							
General Fund		\$203,114					
Roads Capital Fund	\$125,973						
	\$329,087						
Funding Gap		(\$464,516)					
Additional Recommended Revenue Sources							
Street Vacation Fund		\$197,000					
Additional REET	\$267,516						
Total Additional Recommended Revenue Sources \$464,516							

The Ridgecrest Park Retaining Wall project expenditures exceed its current budget. The budget was developed prior to completing the design or obtaining costs from Sound Transit's Contractor (SKH Joint Venture). To fully fund this project, staff has identified two additional funding options:

- Street Vacation the City has previously collected \$197,000 from street vacations that has not been allocated to the project.
- Additional collection of Real Estate Excise Tax (REET) in 2020 the City collected \$515,000 above the projections included in the CIP.

These two sources exceed the additional \$467,696 needed to complete the Betterment Wall project. Staff recommends using the Street Vacation revenue and to supplement that with \$270,696 of surplus 2020 REET. A budget amendment would be processed at a later date so as to increase the revenue authorization if Council authorizes the City Manager to execute this agreement.

RECOMMENDATION

Staff recommends that the City Council authorize the City Manager to execute the Ridgecrest Park Retaining Wall Betterment Agreement for the Lynnwood Link Extension Light Rail Transit Project with Sound Transit.

Approved By: City Manager **DT** City Attorney **JA-T**

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BACKGROUND

The City's Trail Along the Rail Project (Trail Project) is a 2.5-mile-long shared-use path that would roughly be aligned parallel to Sound Transit's LLE Project between NE 145th Street and the NE 195th Street Pedestrian Bridge. The City's Feasibility Study for the Trail identified the preferred alignment. The Trail Project is included in the approved 2021-2026 Capital Improvement Plan (CIP) and is intended to be funded in segments. Currently, limited funding has been allocated to proceed with design. Staff is seeking grant funds to support this project.

Concurrently with the Trail Feasibility Study, Sound Transit was designing the LLE Project which includes a shared-use path that has segments which could eventually become part of the Trail. The LLE Project design at 60% included a segment of shared-use path that extended through Ridgecrest Park between NE 161st and NE 163rd Streets. Because it was included in the LLE Project design, the Trail Feasibility Study identified this segment as "easy" to complete.

However, in mid-2017, Sound Transit found unexpected budget overruns based on the 60% design cost estimate of their project and engaged in a cost reduction process. Sound Transit's proposed changes to the LLE Project design were presented to Council on July 16, 2018. After these cost reduction design changes, the LLE Project no longer included construction of a path segment through Ridgecrest park. However, it also did not preclude future construction of the Trail by the City. More information can be found in the July 16, 2018, staff report on this topic: Sound Transit Lynnwood Link Extension Project Update and Discussion of Comments on In-Progress 90% Design Milestone.

DISCUSSION

With the permit review and start of LLE Project construction, it became apparent to City staff that the Trail segment adjacent to Ridgecrest Park would be difficult, if not impossible, to construct after the LLE Project is completed. However, once Sound Transit rebuilds the NE 161st street end, the grade difference between NE 161st Street and NE 163rd Street is such that the Trail Project could be built at less than 5% grade (thereby satisfying ADA accessibility requirements) in roughly a straight line if there is a retaining wall to support the required fill.

Since the LLE Project Final design included a noise wall in the Ridgecrest Park area, City staff negotiated with Sound Transit to convert that wall to a retaining wall if the City designed and funded the additional cost and if Sound Transit was willing to have its contractor construct the retaining wall as a 'betterment' to the LLE Project. In 2020, CIP funds for Trail Project-related design were used to design an alternate wall that could provide lateral support to the Trail through Ridgecrest Park.

City staff negotiated the costs to build the retaining wall with Sound Transit so as to be included in Sound Transit's contract with its contractor, SKH Joint Venture. The construction costs (\$590,000) were negotiated directly with SKH Joint Venture and are based on detailed estimates for quantities and resources required for the retaining wall work above the original noise wall costs already included in the contract. In addition to construction costs, Sound Transit seeks an administrative fee of 9.3% of the

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construction costs based on its standard administrative support overhead of 6% and estimates of direct costs for the additional work for its design and construction management consultants.

ALTERNATIVES ANALYSIS

An alternative to the Ridgecrest Park Retaining Wall Betterment Agreement would be delaying construction of a retaining wall until Sound Transit has completed its work in the Ridgecrest Park area and constructing a separate support wall. This alternative would require demolition of the noise wall constructed by Sound Transit along with construction of a new retaining wall which would result in significant costs to the City, as construction would be constrained by LLE light rail operation. Another alternative would be to re-route the Trail away from the light rail guideway, but this would not only create a greater Trail footprint within Ridgecrest Park but would result in grades steeper than 5%, rendering this segment of the Trail less accessible and likely used by fewer people.

In reviewing the alternatives, City staff determined that the proposed Betterment Agreement is the most cost-effective alternative to ensure the Trail Project through this segment of Ridgecrest Park.

COUNCIL GOAL(S) ADDRESSED

The proposed Ridgecrest Park Retaining Wall Betterment Agreement with Sound Transit supports the 2019-2021 Council Goal 3 – "Continue preparation for regional mass transit in Shoreline" and more specifically Action Step 6 - "Create non-motorized connections to the light rail stations and provide for multiple transportation options in and between the Station subareas by continuing to coordinate design elements of the Trail Along the Rail."

RESOURCE/FINANCIAL IMPACT

The 2021-2026 CIP includes the Trail Along the Rail Project. A summary of the project expenditures and budget for the Ridgecrest Park Retaining Wall project is shown below:

Expenses		
City Direct Expenses		(\$10,000)
Design and Cost Estimating		(\$77,563)
Betterment Agreement (ST)		(\$703,640)
Construction Costs	(\$590,000)	
ST Costs (9.3%)	(\$54,640)	
Contingency	(\$59,000)	
Permitting		(\$2,400)
	Total Expenses	(\$793,603)
Revenue		
General Fund		\$203,114
Roads Capital Fund		\$125,973
	Total Revenue	\$329,087

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Funding Gap	(\$464,516)
Additional Recommended Revenue Sources	
Street Vacation Fund	\$197,000
Additional REET	\$267,516
Total Additional Recommended Revenue Sources	\$464,516

The Ridgecrest Park Retaining Wall project expenditures exceed its current budget. The budget was developed prior to completing the design or obtaining costs from Sound Transit's Contractor (SKH). To fully fund this project, staff has identified two additional funding options:

- Street Vacation the City has previously collected \$197,000 from street vacations that has not been allocated to the project.
- Additional collection of Real Estate Excise Tax (REET) in 2020 the City collected \$515,000 above the projections included in the CIP.

These two sources exceed the additional \$467,696 needed to complete the Betterment Wall project. Staff recommends using the Street Vacation revenue and to supplement that with \$270,696 of surplus 2020 REET. A budget amendment would be processed at a later date so as to increase the revenue authorization if Council authorizes the City Manager to execute this agreement.

RECOMMENDATION

Staff recommends that the City Council authorize the City Manager to execute the Ridgecrest Park Retaining Wall Betterment Agreement for the Lynnwood Link Extension Light Rail Transit Project with Sound Transit.

<u>ATTACHMENT</u>

Attachment A – Ridgecrest Park Retaining Wall Betterment Agreement for the Lynnwood Link Extension Project with Sound Transit

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RIDGECREST PARK RETAINING WALL BETTERMENT FOR THE LYNNWOOD LINK LIGHT RAIL TRANSIT PROJECT

GA 0207-20/City Receiving #9887

THIS AGREEMENT, effective upon the date of the latest signature, is entered into by and between the CITY OF SHORELINE, a Washington municipal corporation (the "City") and the CENTRAL PUGET SOUND REGIONAL TRANSIT AUTHORITY ("Sound Transit"), a regional transit authority organized under the laws of the State of Washington, collectively "Parties" and individually "Party."

RECITALS

- 1. Sound Transit is a governmental entity created pursuant to RCW 81.104 and 81.112 with all powers necessary to implement a high capacity transit system within its boundaries in King, Pierce, and Snohomish counties.
- 2. The City is a non-charter optional municipal code city organized pursuant to chapter 35A RCW and incorporated under the laws of the State of Washington, with the authority to enact laws and enter into agreements to promote the health, safety and welfare of its citizens and for other lawful purposes.
- 3. On April 23, 2015, the Sound Transit Board selected and authorized the implementation of the preferred alternative alignment for the Lynnwood Link Light Rail Extension Project ("LLE Project") in Resolution 2015-05 ("Alignment Resolution").
- 4. In coordination with the City, Sound Transit is in the process of designing and constructing the LLE Project, within the City's boundaries as described in the Alignment Resolution, including without limitation a public rail transit line, stations, other infrastructure, improvements, public transit and passenger amenities, and mitigation measures associated there with.
- 5. The City is the owner of a municipal park commonly known as Ridgecrest Park (the "Park"), located just east of Interstate-5, of which the western edge is parallel and adjacent to the LLE Project's future light rail guideway.
- 6. As part of that the interagency coordination, the City identified an improvement to the designed and permitted noise wall bordering the Park that is not required to execute the LLE Project, but would provide a public benefit and promote an efficient use of public funds if included as part of the LLE Project.
- 7. The City identified improvement consists of constructing a retaining wall ("Retaining Wall") along the westernmost ten (10) feet of the Park in support of the City's future construction of the City's "Trail Along the Rail" project, a non-motorized, shared-use path, in lieu of the noise wall originally designed and permitted.
- 8. In accordance with Sound Transit's Scope Control Policy (Resolution No. R2009-24), the Parties desire to enter into this Agreement to set forth their respective responsibilities, define the funding commitments for the Retaining Wall and project elements, and build effective cooperation between the Parties.

NOW, THEREFORE, in consideration of the recitals, terms, conditions, and covenants contained herein, the Parties herby agree as follows:

AGREEMENT

A. SCOPE OF WORK

Sound Transit and the City have coordinated during the development of the preliminary design of the Retaining Wall. The purpose of this Agreement is to identify and define the Parties' responsibilities with respect to the Retaining Wall scope of work.

The Retaining Wall will be constructed by Sound Transit's contractor ("Contractor") and the scope of work will be added to the LLE Project L200 contract ("LLE Contract") via a change order. The Retaining Wall will support a City-planned non-motorized, shared use pedestrian and bicycle path (the "Trail Along the Rail") along the west side of the Park and eventually connecting from NE 145th Street to both light rail stations in the City and to the NE 195th Street non-motorized bridge crossing Interstate-5. The Retaining Wall and the preceding items are more fully identified in **Exhibit A** ("Retaining Wall Scope of Work").

B. CITY'S RIGHTS & RESPONSIBILITIES

- 1. **Priority of Work.** The City understands and agrees that Sound Transit will advance the LLE Project as a whole as a superior goal to advancing the Retaining Wall, if there is a conflict in the priority of the work. The Retaining Wall work will not delay the timely completion of the LLE Project, and Sound Transit has the authority to act to maintain the LLE Project schedule.
- 2. Design of Retaining Wall. The City will be responsible for the design of the Retaining Wall in accordance with all applicable federal, state, and local laws, regulations and ordinances; City and Sound Transit design criteria; the LLE Contract; and the minimum standards established in this Agreement.
 - a. **Conflict of Interest.** The City utilized KPFF, Inc. for design of the Retaining Wall. Sound Transit also utilized KPFF, Inc. on other elements of the LLE Project. As construction occurs, both the City's and Sound Transit's use of KPFF, Inc. may result in a conflict of interest. Therefore, the City agrees to cooperate with Sound Transit in regard to KPFF, Inc. services related to the Retaining Wall design.
- **3. Permitting.** Subject to Sound Transit's authorization and as soon as reasonably possible after execution of this Agreement, the City will submit the necessary revisions to Site Development Permit DEV19-0328, so as to replace the currently included noise wall in the Park with the Retaining Wall.
- **4. Construction Observation**. The City understands and agrees that construction of the Retaining Wall will be managed by Sound Transit. The City has the right, at all reasonable times, to observe construction of the Retaining Wall and, at its own cost and expense, request additional quality verification or testing of the construction work to be performed. City will request access to observe the Retaining Wall construction work, and Sound Transit will not unreasonably deny any such requests.

5. Funding.

- a. Subject to the terms of this Agreement, the City agrees to reimburse Sound Transit for the Estimated Total Cost, as defined below, to construct the Retaining Wall. The City acknowledges that it has funding available for this initial estimate, and that it will provide funding for any valid increases to this amount in accordance with this Agreement.
- b. Notwithstanding any estimated cost, the City agrees to pay all administrative and construction costs related to the Retaining Wall, except as provided herein.
- c. The City is not obligated to pay for costs resulting from the sole or partial negligent acts or omissions of Sound Transit or its contractors (if the cost increase is due in part the negligent acts or omissions of Sound Transit or its contractors, the City is not obligated to pay for the portion of the cost increases attributable to such negligent acts or omissions).
- d. The Parties have agreed to the initial estimate as described in **Exhibit B.** The Parties may further update Exhibit B by mutual written agreement to incorporate cost changes as contemplated by this Agreement.
- e. The Estimated Total Cost for the Retaining Wall will consist of:
 - i. Contractor's Negotiated Price. The Contractor's proposed price schedule for the Retaining Wall, which will be issued as a change order to the LLE Contract.
 - ii. Sound Transit's Administrative Costs. Sound Transit's costs to administer and oversee the construction of the Retaining Wall. Sound Transit's administrative costs will be 9.3% of the Contractor's Negotiated Price and all approved changes.
 - iii. Contingency. The City will allocate a contingency fund equal to 10% of the Contractor's Negotiated Price to be used for payment arising out of changes. The Contingency will be used to pay for any changes to the Retaining Wall which will increase the cost beyond the Contractor's Negotiated Price and approved according to the provisions of Section D(2) below.
- f. Notwithstanding this section, the City is obligated to reimburse Sound Transit for all administrative and construction costs related to the Retaining Wall except as provided herein.
- **6. Regulatory Authority.** The City acknowledges it has dual roles concerning the LLE Project and Retaining Wall, as both a land use regulator for the LLE Project within city limits and the funder of the Retaining Wall. Nothing in this Agreement will be deemed an alteration, expansion, or restriction the City's regulatory authority nor a predetermination of the compliance of the Retaining Wall or the LLE Project with applicable federal, state, or local laws, codes, and regulations.
- 7. Acceptance. The City will be invited to attend acceptance walk-through inspections and may participate in creating acceptance walk-through inspections for the Retaining Wall, consistent with the terms of the LLE Contract. Sound Transit acknowledges that the City's acceptance, which will not be unreasonably withheld, is conditioned on (i) Sound Transit scheduling the acceptance walk-through inspection at a time that the City Designated Representative has agreed to be physically present or to send an authorized representative to be physically present on behalf of the City, (ii) all punch-list items being adequately

addressed according to the requirements of the LLE Contract and to the City's reasonable satisfaction and (iii) that any remaining construction activities related to the Retaining Wall are completed and the Contractor is demobilized for any work pertaining to the Retaining Wall.

C. SOUND TRANSIT'S RIGHTS & RESPONSIBILITIES

- 1. Construction of Retaining Wall. Sound Transit will include the Retaining Wall work in the LLE Contract as a change order to the existing LLE Contract. If no intervening factors arise between execution of this Agreement and issuance of a change order to the LLE Contract that would otherwise make construction of the Retaining Wall inadvisable, Sound Transit will construct the Retaining Wall at the Contractor's Negotiated Price shown in Exhibit B. Sound Transit will be solely responsible for administering all aspects of the LLE Contract and the Retaining Wall construction work.
- 2. Notice of Costs. Sound Transit will notify the City in writing when the expenditures for the Retaining Wall have reached eighty percent (80%) of Estimated Total Cost and, at any time Sound Transit has reason to believe the costs for the Retaining Wall could exceed the Estimated Total Cost.

D. JOINT OBLIGATIONS – CITY AND SOUND TRANSIT

1. Communication and Participation. As soon as reasonably possible after execution of this Agreement, the Designated Representatives for the City and Sound Transit will develop a communication and participation plan in relationship to the Retaining Wall. At a minimum, the communication plan will provide for the City's participation in meetings and field inspections, review of documents, and inclusion in all correspondence, written or oral, between Sound Transit and its Contractor.

2. Changes.

- a. The City will pay Sound Transit's costs incurred for changes related to the Retaining Wall work approved by the City. Changes include, without limitation, any increases in cost or time caused by unknown conditions in the area of the Retaining Wall relative to the LLE Project, or causes not within the control of the Contractor or Sound Transit, or other valid bases for equitable adjustment pursuant to the LLE Contract.
- b. Sound Transit will have authority to administer contract changes within the limits of the Contingency included in the Estimated Total Cost in addition to the Contractor's Negotiated Price, and will make reasonable efforts to cause the Contractor to avoid or mitigate impacts that would cause Retaining Wall costs to exceed the agreed Estimated Total Cost.
- c. Changes which increase the cost within the Contingency will be divided into three categories:
 - **Level 1:** Changes that are not site related which increase the cost of the Retaining Wall by no more than \$10,000.00 will be considered automatically approved by the City without any further action necessary. Upon receipt of a Level 1 change, Sound Transit will promptly provide the City notice of the change and its estimated cost

and/or schedule impact. Sound Transit will promptly provide an updated price for the Retaining Wall showing the Contractor's Negotiated Price, cost of all approved changes, and the remaining Contingency.

Level 2: Changes that are not site related which increase the cost of the Retaining Wall by more than \$10,000.00 must be submitted to the City for prior approval. The City will review Level 2 changes and, within five (5) calendar days of receipt of the change and estimated costs and/or schedule impacts from Sound Transit, provide Sound Transit with its approval or objection. If the City objects to approval of the change, the City will provide written documentation supporting its objection to Sound Transit. After review of all comments on a proposed change, the Parties will determine whether a change materially affects LLE Project requirements, and if so, the Parties will agree as to whether the proposed change is to be approved, modified, or rejected. After approval or modification, Sound Transit will promptly provide the City with updated price for the Retaining Wall showing the Contractor's Negotiated Price, cost of all approved changes, and the remaining Contingency. Change disputes will be subject to the Dispute Resolution process described in Section H.

Unsuitable Site Conditions: Sound Transit will notify the City of any changes needed due to unsuitable site conditions. The Parties will coordinate to determine a solution. In order to maintain LLE Contract schedule and minimize delay, time and materials costs will be tracked and considered automatically approved. Sound Transit will promptly provide the City notice of change and its estimated costs and/or schedule impacts. Sound Transit will promptly provide an updated price for the Retaining Wall showing the Contractor's time and materials, and the remaining Contingency.

3. Claims. The City will be responsible for all claims and disputes which arise out of the construction of the Retaining Wall and are outside the control of Sound Transit. The City will not be liable for any disputes or claims related to the Retaining Wall which may arise due to the improper or negligent administration of the LLE Contract by Sound Transit or other negligent acts or omissions by Sound Transit. In consultation with the City, Sound Transit will consider and administer all claims and disputes related to the Retaining Wall in the same manner as any claim or dispute on the LLE Project, in accordance with the LLE Contract. The City may direct Sound Transit in administration of all claims and disputes related exclusively with the Retaining Wall. Sound Transit will inform the City of all disputes or claims that could increase the Estimated Total Cost of the Retaining Wall. The City will pay Sound Transit its reasonable defense costs (attorney's fees and consultant's fees, expenses, and costs; alternative dispute resolution and court costs and expenses), and any settlements, judgments, or awards that are attributable to the City ("Actual Costs"), including those that have been settled through the dispute resolution processes set forth in the LLE Contract. Sound Transit will pay that portion of any Actual Costs that are attributable to the acts or omissions of Sound Transit or its contractor. If a dispute or claim relates to both the Retaining Wall and other LLE Contract scopes, the City will be liable for its pro rata share of the Actual Costs. Sound Transit will consult with the

City for all claims and disputes which relate to both the Retaining Wall and other LLE Contract scopes and take all the City input in good faith and in consideration of the Retaining Wall's relative value to the overall claim or dispute.

- **4. Retaining Wall Ownership and Maintenance.** The Retaining Wall will be owned by Sound Transit as a component of the LLE Project. Sound Transit and the City will share in the responsibility for maintenance of the Retaining Wall and provided herein.
 - a. Operations and Maintenance Agreement. As soon as reasonably possible after execution of this Agreement, the City and Sound Transit will enter into a separate Operations and Maintenance Agreement for facilities associated with the LLE Project, including the Retaining Wall, so as to more specifically identify the Parties' responsibilities for operations and maintenance of shared or interrelated facilities, such as repairs, replacement, and operationality; the process for track access; equitable allocation of costs; and processes for decision making and dispute resolution. This agreement will be executed no later than Sound Transit's final acceptance of the LLE Project as defined in the LLE Contract.
 - b. In regard to the Retaining Wall, the Operation and Maintenance Agreement will address, at a minimum, the following:
 - i. City's Maintenance Responsibilities.

After acceptance as provided in Section B(7) above, the City will be responsible for periodic inspection and maintenance of the:

East side of the Retaining Wall, including graffiti, vegetation management, and other maintenance activities that can be reasonably completed from the east side of the Retaining Wall; Security fencing related to the Retaining Wall; and Footing drains associated with the Retaining Wall.

ii. Sound Transit's Maintenance Responsibilities.

After acceptance as provided in Section B(7) above, Sound Transit will be responsible for periodic inspection and maintenance of:

West side of the Retaining Wall including graffiti, vegetation management, and other maintenance activities that can be completed from the west side of the Retaining Wall; and Fencing and Drainage Based on its periodic inspections, Sound Transit will promptly bring any issues identified in regard to the fencing or drainage to the City's attention.

iii. Joint Maintenance Responsibilities

As part of the periodic inspections, both the City and Sound Transit will inspect the Retaining Wall for structural integrity. If structural repairs and/or replacement is necessary, the Parties will work together in addressing these needs and the associated costs..

E. PAYMENT

- 1. Payment. The City will pay Sound Transit for all costs incurred by Sound Transit for construction of the Retaining Wall in accordance with this Agreement.
- 2. Invoicing. Sound Transit will invoice the City for fifty percent (50%) of the amount agreed to in Exhibit B within thirty (30) calendar days of the execution of this Agreement. Upon substantial completion of the Retaining Wall, Sound Transit will invoice the City for the remaining fifty percent (50%) plus any additional charges incurred in accordance with Section D(2). The City will pay Sound Transit's invoice within thirty (30) calendar days of receipt of an adequately supported invoice. The City will have access to all supporting documentation for all invoiced amounts. Sound Transit will maintain adequate records for amounts invoiced as provided in Section J below.

F. TERM AND TERMINATION

- 1. **Term.** This Agreement will remain in effect until all required construction as set forth herein is completed and accepted by City; the an easement for the Retaining Wall is recorded, an Operations and Maintenance Agreement is executed, final payment, is made by the City, and all claims related to the Retaining Wall have been resolved.
- **2. Termination**. The Parties may terminate all or part of this Agreement by mutual agreement signed by both Parties.
- 3. Notice of Default. Neither Party will be in default under this Agreement unless it has failed to perform a material obligation under this Agreement for a period of thirty (30) calendar days after written notice of default from the non-defaulting Party. A notice of default will specify the nature of the alleged default and the manner in which the default may be cured satisfactorily. If the nature of the alleged default is such that it cannot be reasonably cured within a thirty (30) day period, then the defaulting Party must initiate reasonable actions to cure the default within the thirty (30) day period, and the defaulting Party must thereafter diligently prosecute such cure to completion. If the defaulting Party fails to timely cure the default, the non-defaulting Party may terminate this Agreement.
- 4. City Failure to Pay. The City's failure to timely pay a valid invoice will constitute an immediate default and is not subject to the notice and cure periods described above. Sound Transit will provide written notice of the missed payment and the City will have fifteen (15) calendar days to remit payment plus interest of 12% per annum. If the City fails to remit payment, Sound Transit may terminate this Agreement. If the City disputes a payment amount, it must provide written notice to Sound Transit of the contested invoice amount and the basis of such objection within the thirty (30) calendar days of receipt of the invoice. The Parties will utilize the dispute resolution process in Section H to address this dispute.
- 5. Effect of Termination. If this Agreement is terminated for any reason, the City will reimburse Sound Transit for all costs incurred by Sound Transit due to the inclusion of the Retaining Wall in the LLE Contract, including without limitation, all costs incurred by the subsequent removal of the Retaining Wall from the LLE Contract and any requirements for restoring conditions disturbed during any construction work that may have occurred.

G. INDEMNIFICATION

- 1. Mutual Indemnification. Each Party will defend, indemnify and save harmless the other Party, its officers, officials, employees, and agents, while acting within the scope of their employment as such, from any and all costs, claims, judgments, and/or awards of damages (both to persons and property), arising out of, or in any way resulting from, its negligent acts or omissions. Neither Party will be required to defend, indemnify or save harmless the other Party if the claim, suit, or action for injuries, death, or damages (both to persons and property) is caused by the sole negligence of the other Party.
- 2. Concurrent Negligence. Where such claims, suits, or actions result from concurrent negligence of the Parties, or involve those actions covered by RCW 4.24.115, the indemnity provisions provided herein will be valid and enforceable only to the extent of the Party's own negligence. Each Party agrees that its obligations under this subparagraph extend to any claim, demand, and/or cause of action brought by, or on behalf of, any of its employees or agents. For this purpose, each Party, by mutual negotiation, hereby waives, with respect to the other party only, any immunity that would otherwise be available against such claims under the Industrial Insurance provisions of Title 51 RCW. This indemnification was specifically and mutually negotiated by each of the Parties and will survive the termination of this Agreement.
- **3. Survival.** The indemnification obligations provided in this Section G will survive termination of this Agreement.

H. DISPUTE RESOLUTION

- 1. Level One. The Designated Representatives of each Party will use their best efforts to resolve any disputes between the Parties related to or arising out of this Agreement. If an issue is not resolved by informal cooperative efforts, the Designated Representative will notify the other in writing of any issue or dispute they believe requires resolution. Upon receipt of written notification, the Designated Representatives will meet within three days to attempt to resolve the matter. Supporting documentation and information will be provided as requested.
- 2. Level Two. In the event that a dispute or issue is not resolved by the Designated Representatives, the matter will be referred to the Sound Transit Executive Project Director Lynnwood Link and the City's Public Works Director, or their designee. The Designated Representatives, individually or jointly, will provide written notice to the Directors that they were unable to resolve the dispute. The Directors will meet within seven (7) business days of the date of the written notice and in good faith attempt to resolve the matter.
- 3. Level Three. In the event these persons are unable to resolve the matter, the matter will be referred to the Sound Transit Design and Engineering Construction Management Executive Director or Designee and the City of Shoreline City Manager. The Level 2 Directors, individually or jointly, will provide written notice to the Executive Director and City Manager that they were unable to resolve the dispute. The Executive Director and the City Manager will meet and in good faith attempt to resolve the matter within fourteen (14) business days of the date of the written notice.

4. Exhaustion. This Dispute Resolution process will be exhausted prior to initiating legal action, but will not be considered the exclusive opportunity or tool to resolve any issues prior to initiating legal action.

I. DESIGNATED REPRESENTATIVES

The Designated Representatives for each Party, as identified in **Exhibit C**, will be responsible for coordination of any notices or communications between the Parties and will act as the point of contact for each Party for all matters related to this Agreement. The Parties reserve the right to change Designated Representatives by providing written notice to the other Party during the term of this Agreement. Any correspondence or communications related to the Retaining Wall will be made exclusively by and through Sound Transit's Designated Representative or their designee.

J. RECORDS

- 1. Records to be Maintained. Sound Transit will maintain accounts and records, including contract and financial records, which sufficiently and properly reflect all costs of any nature incurred by Sound Transit and all monies paid by the City to Sound Transit. These records will be maintained for a period of six (6) years after termination or expiration of this Agreement unless permission to destroy the records is granted by the City and the destruction is authorized under RCW Chapter 40.14.
- 2. Inspection. All such Sound Transit's records and documents will be available during regular business hours, upon reasonable request, for inspection, review or audit by the City during the performance of this Agreement and for the required six (6) year period.
- 3. Public Records Act. The Parties are both public agencies subject to Washington's Public Records Act, chapter 42.56 RCW, and that all documents produced in connection with this Agreement may be deemed a public record as defined in the Public Records Act and that if either Party receives a public records request, unless a statute exempts disclosure, the Party must disclose the record to the requestor. Release of a public record pursuant to the Public Records Acts will not be considered a breach of this Agreement nor will the disclosing Party be liable for any cost or expense incurred by the other Party due to disclosure.

K. GENERAL PROVISIONS

- 1. Governing Law and Exclusive Venue. This Agreement will be interpreted, construed and enforced in accordance with the laws of the State of Washington. The exclusive venue for any action under this Agreement will be King County, Washington.
- 2. Successors and Assigns. This Agreement will be binding upon and inure to the benefit of the successors and assigns of the City and Sound Transit. Neither Party may assign the rights and responsibilities set forth in this Agreement without the express written consent of the other Party.
- **3. Time.** Time is of the essence in every provision of this Agreement. Unless otherwise set forth in this Agreement, the reference to "days" will mean calendar days. If any time for action occurs on a weekend or legal holiday, then the time period will be extended automatically to the next business day.

- **4. Notice.** All notices or correspondence related to this Agreement will be in writing, addressed to the appropriate Designated Representative. Any notice, request, demand or other communication made pursuant to this Agreement will be deemed received three days after it is mailed, or upon written confirmation by the recipient of receipt by email or by hand delivery.
- **5. No Third-Party Beneficiaries.** This Agreement is made and entered into for the sole protection and benefit of the Parties hereto and their successors and assigns. No other person will have any right of action based upon any provision of this Agreement.
- **6. No Joint Venture.** No joint venture or partnership is formed as a result of this Agreement. No employees, agents or subcontractors of one party will be deemed, or represent themselves to be, employees of any other party.
- 7. Construction. This Agreement has been reviewed and revised by legal counsel for all parties and no presumption or rule that ambiguity will be construed against the party drafting the document will apply to the interpretation or enforcement of this Agreement. The Parties intend this Agreement to be interpreted to the full extent authorized by applicable law.
- **8.** Costs. Each Party will be responsible for its own costs, including legal fees, incurred in negotiating or finalizing this Agreement, unless otherwise agreed in writing by the Parties.
- 9. Force Majeure. Neither party will be liable to the other or deemed in breach or default for any failure or delay in performance under this Agreement during the time and to the extent its performance is prevented by reasons of Force Majeure. For the purposes of this Agreement, Force Majeure means an occurrence that is beyond the reasonable control of and without fault or negligence of the party claiming force majeure and which, by exercise of due diligence of such party, could not have been prevented or overcome. Force Majeure will include natural disasters, including fire, flood, earthquake, windstorm, avalanche, mudslide, and other similar events; acts of war or civil unrest when an emergency has been declared by appropriate governmental officials; acts of civil or military authority; freight embargoes; epidemics; quarantine restrictions; labor strikes; boycotts; terrorist acts; riots; insurrections; explosions; and nuclear accidents. A party claiming suspension or termination of its obligations due to force majeure will give the other party prompt written notice, but no more than five (5) working days after the event, of the impediment and its effect on the ability to perform; failure to provide such notice will preclude recovery under this provision.
- 10. Amendments. This Agreement may be amended only by a written instrument executed by each of the Parties hereto. The Designated Representatives may agree upon amendments to the design for the Retaining Wall and such amendments will be binding upon the Parties without the need for formal approval by the Sound Transit Board and the Shoreline City Council as long as the amendments do not materially alter the functionality or design of the Retaining Wall.
- 11. Entire Agreement. This Agreement constitutes the entire agreement of the Parties with respect to the subject matters of this Agreement, and supersedes any and all prior


- negotiations (oral and written), understandings and agreements with respect hereto. However, the Parties will negotiate and execute such ancillary agreements as may be required to implement this Agreement.
- **12. Headings.** Section headings are intended as information only and will not be construed with the substance of the section they caption.
- **13. Exhibits.** All exhibits attached to this Agreement are hereby incorporated into and made part of this Agreement.
- **14. Execution of this Agreement**. This Agreement may be executed electronically on a platform agreed to by the Parties. This Agreement may be executed in several counterparts, each of which will be deemed an original, and all counterparts together will constitute but one and the same instrument.
- **15. Severability.** If any of the terms and conditions of this Agreement are determined to be invalid or unenforceable by a court of competent jurisdiction, the remaining terms and conditions thereby will remain in full force and effect.


CENTRAL PUGET SOUND REGIONAL THE CITY OF SHORELINE TRANSIT AUTHORITY (SOUND TRANSIT)

By:	By:
Kimberly Farley, Deputy Chief Executive	
Officer	
Date:	Date:
Authorized by Motion No	Approved by City Council Motion on March 15, 2021
Approved as to form:	Approved as to form:
By:	By:
Mattelyn Tharpe, Legal Counsel I	City Attorney's Office

EXHIBITS:

Retaining Wall Scope of Work Retaining Wall Cost Estimate Exhibit A: Exhibit B: Designated Representatives Exhibit C:

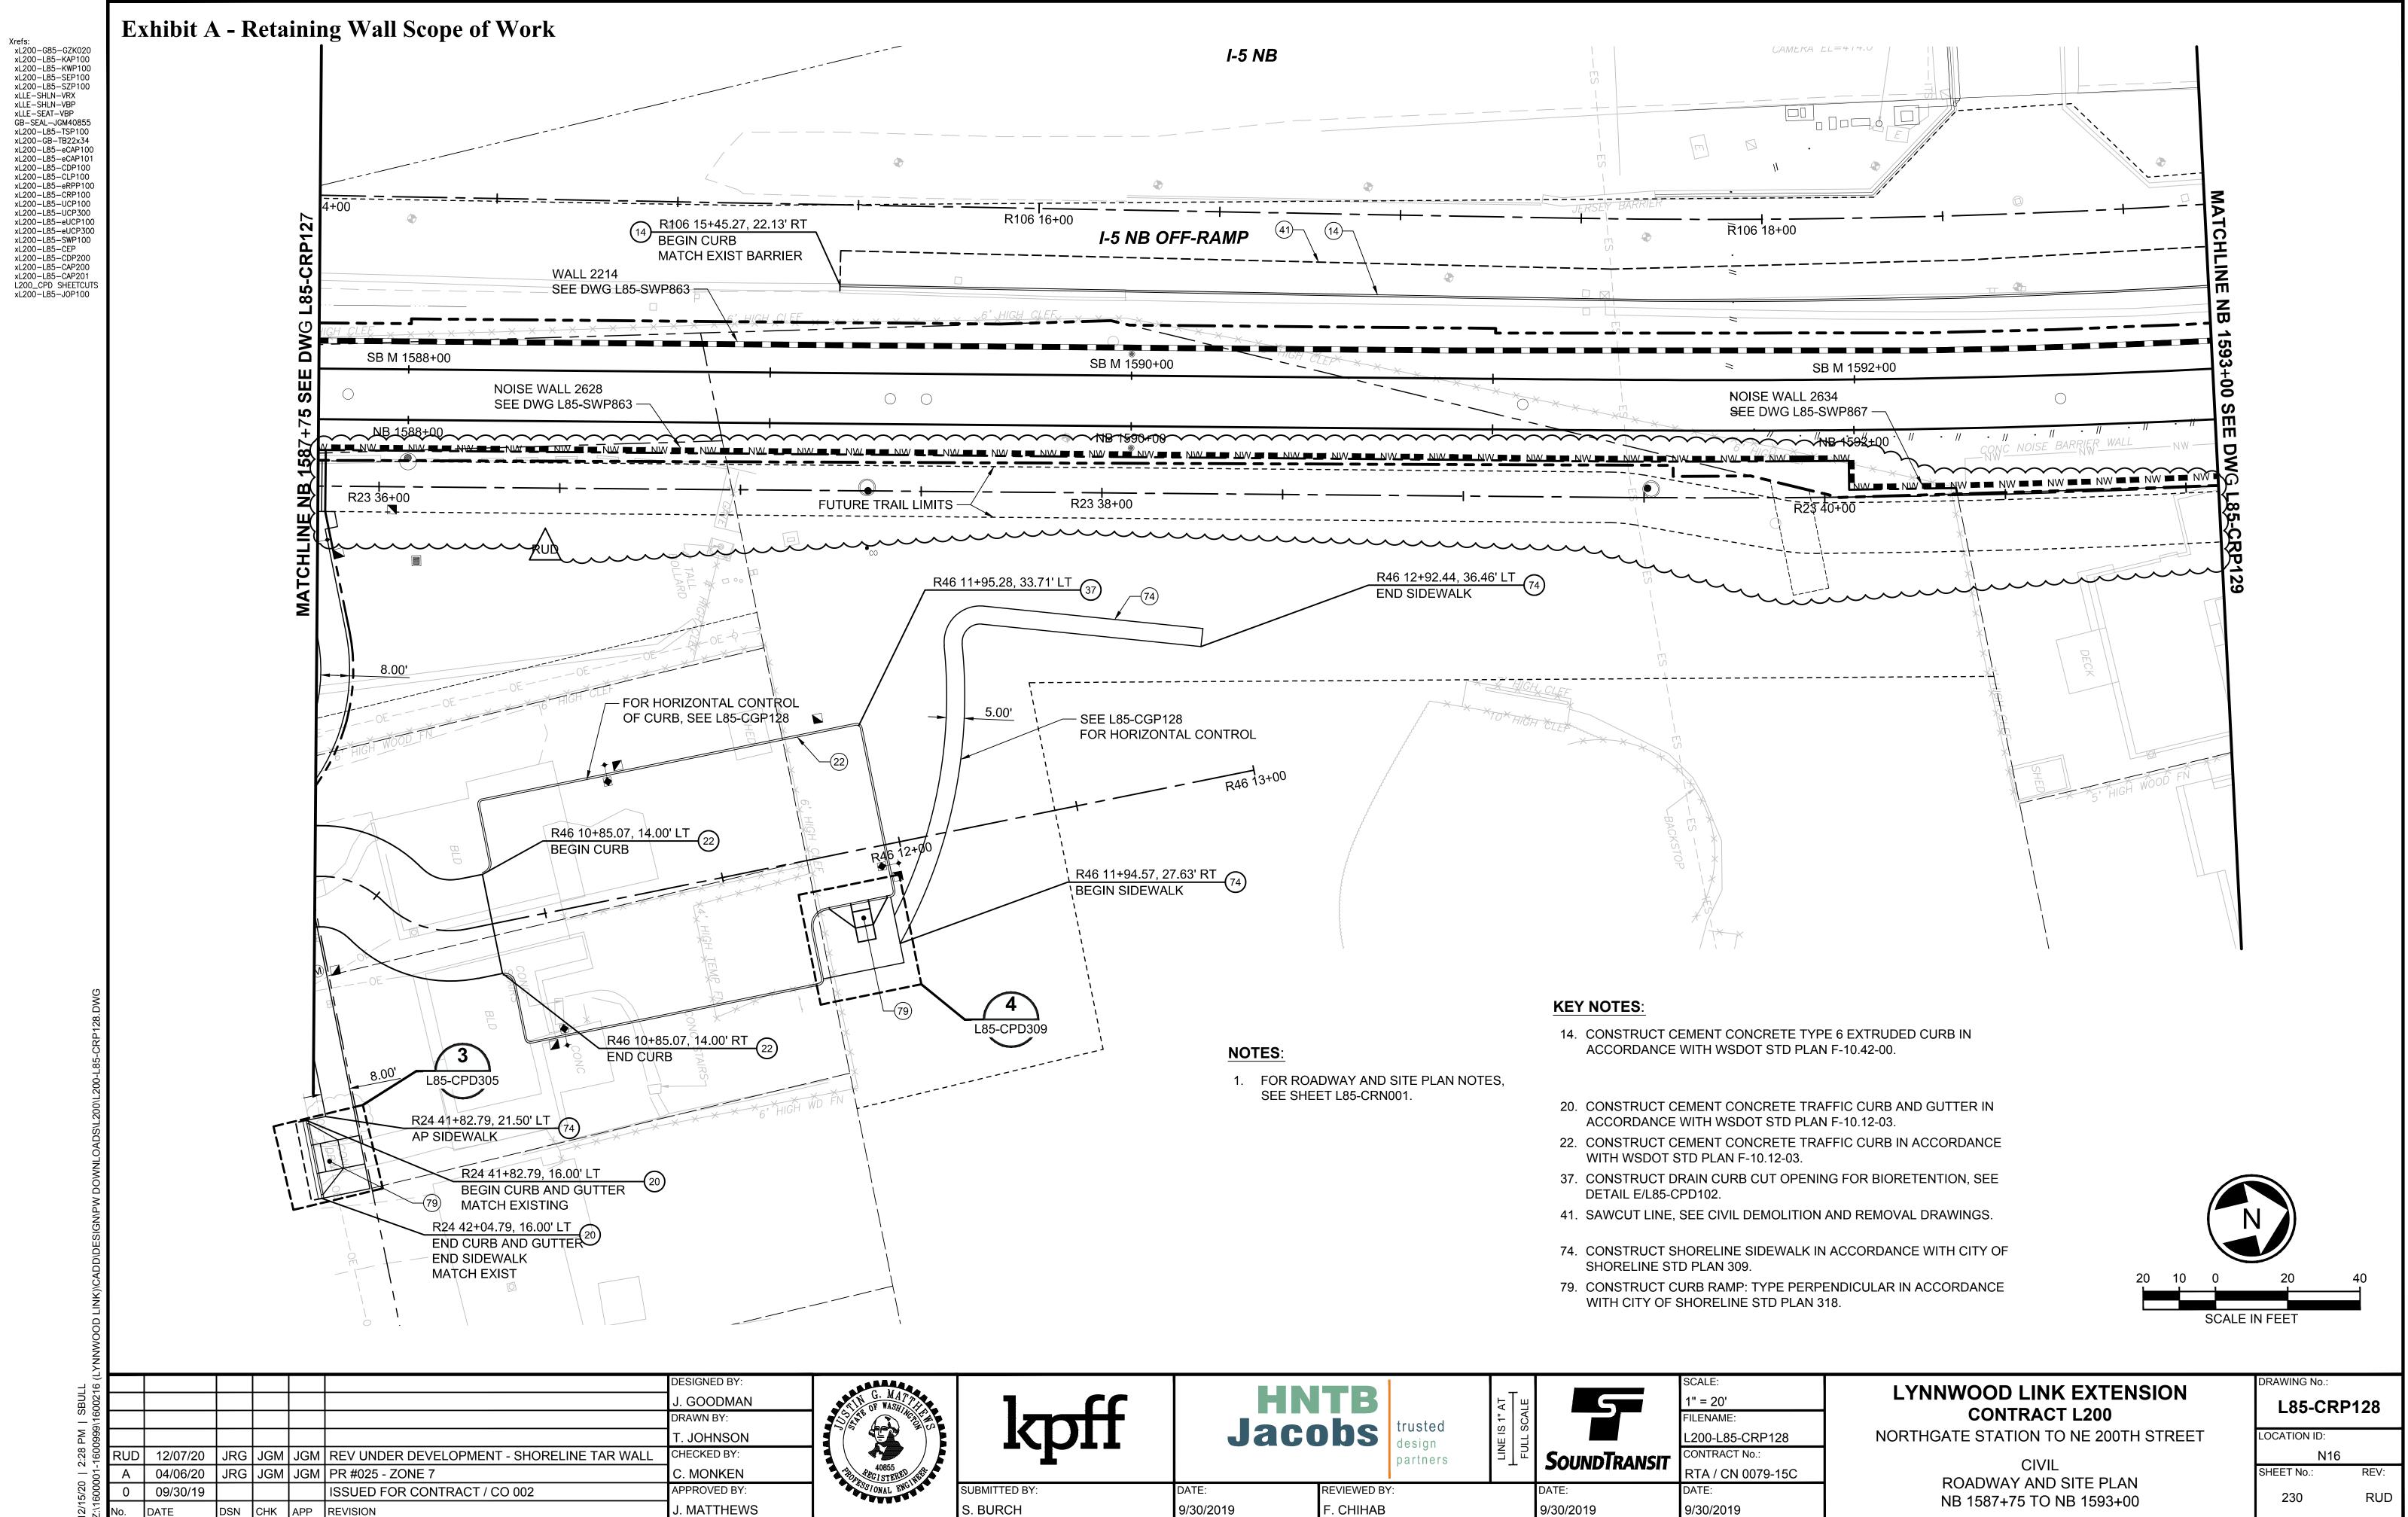

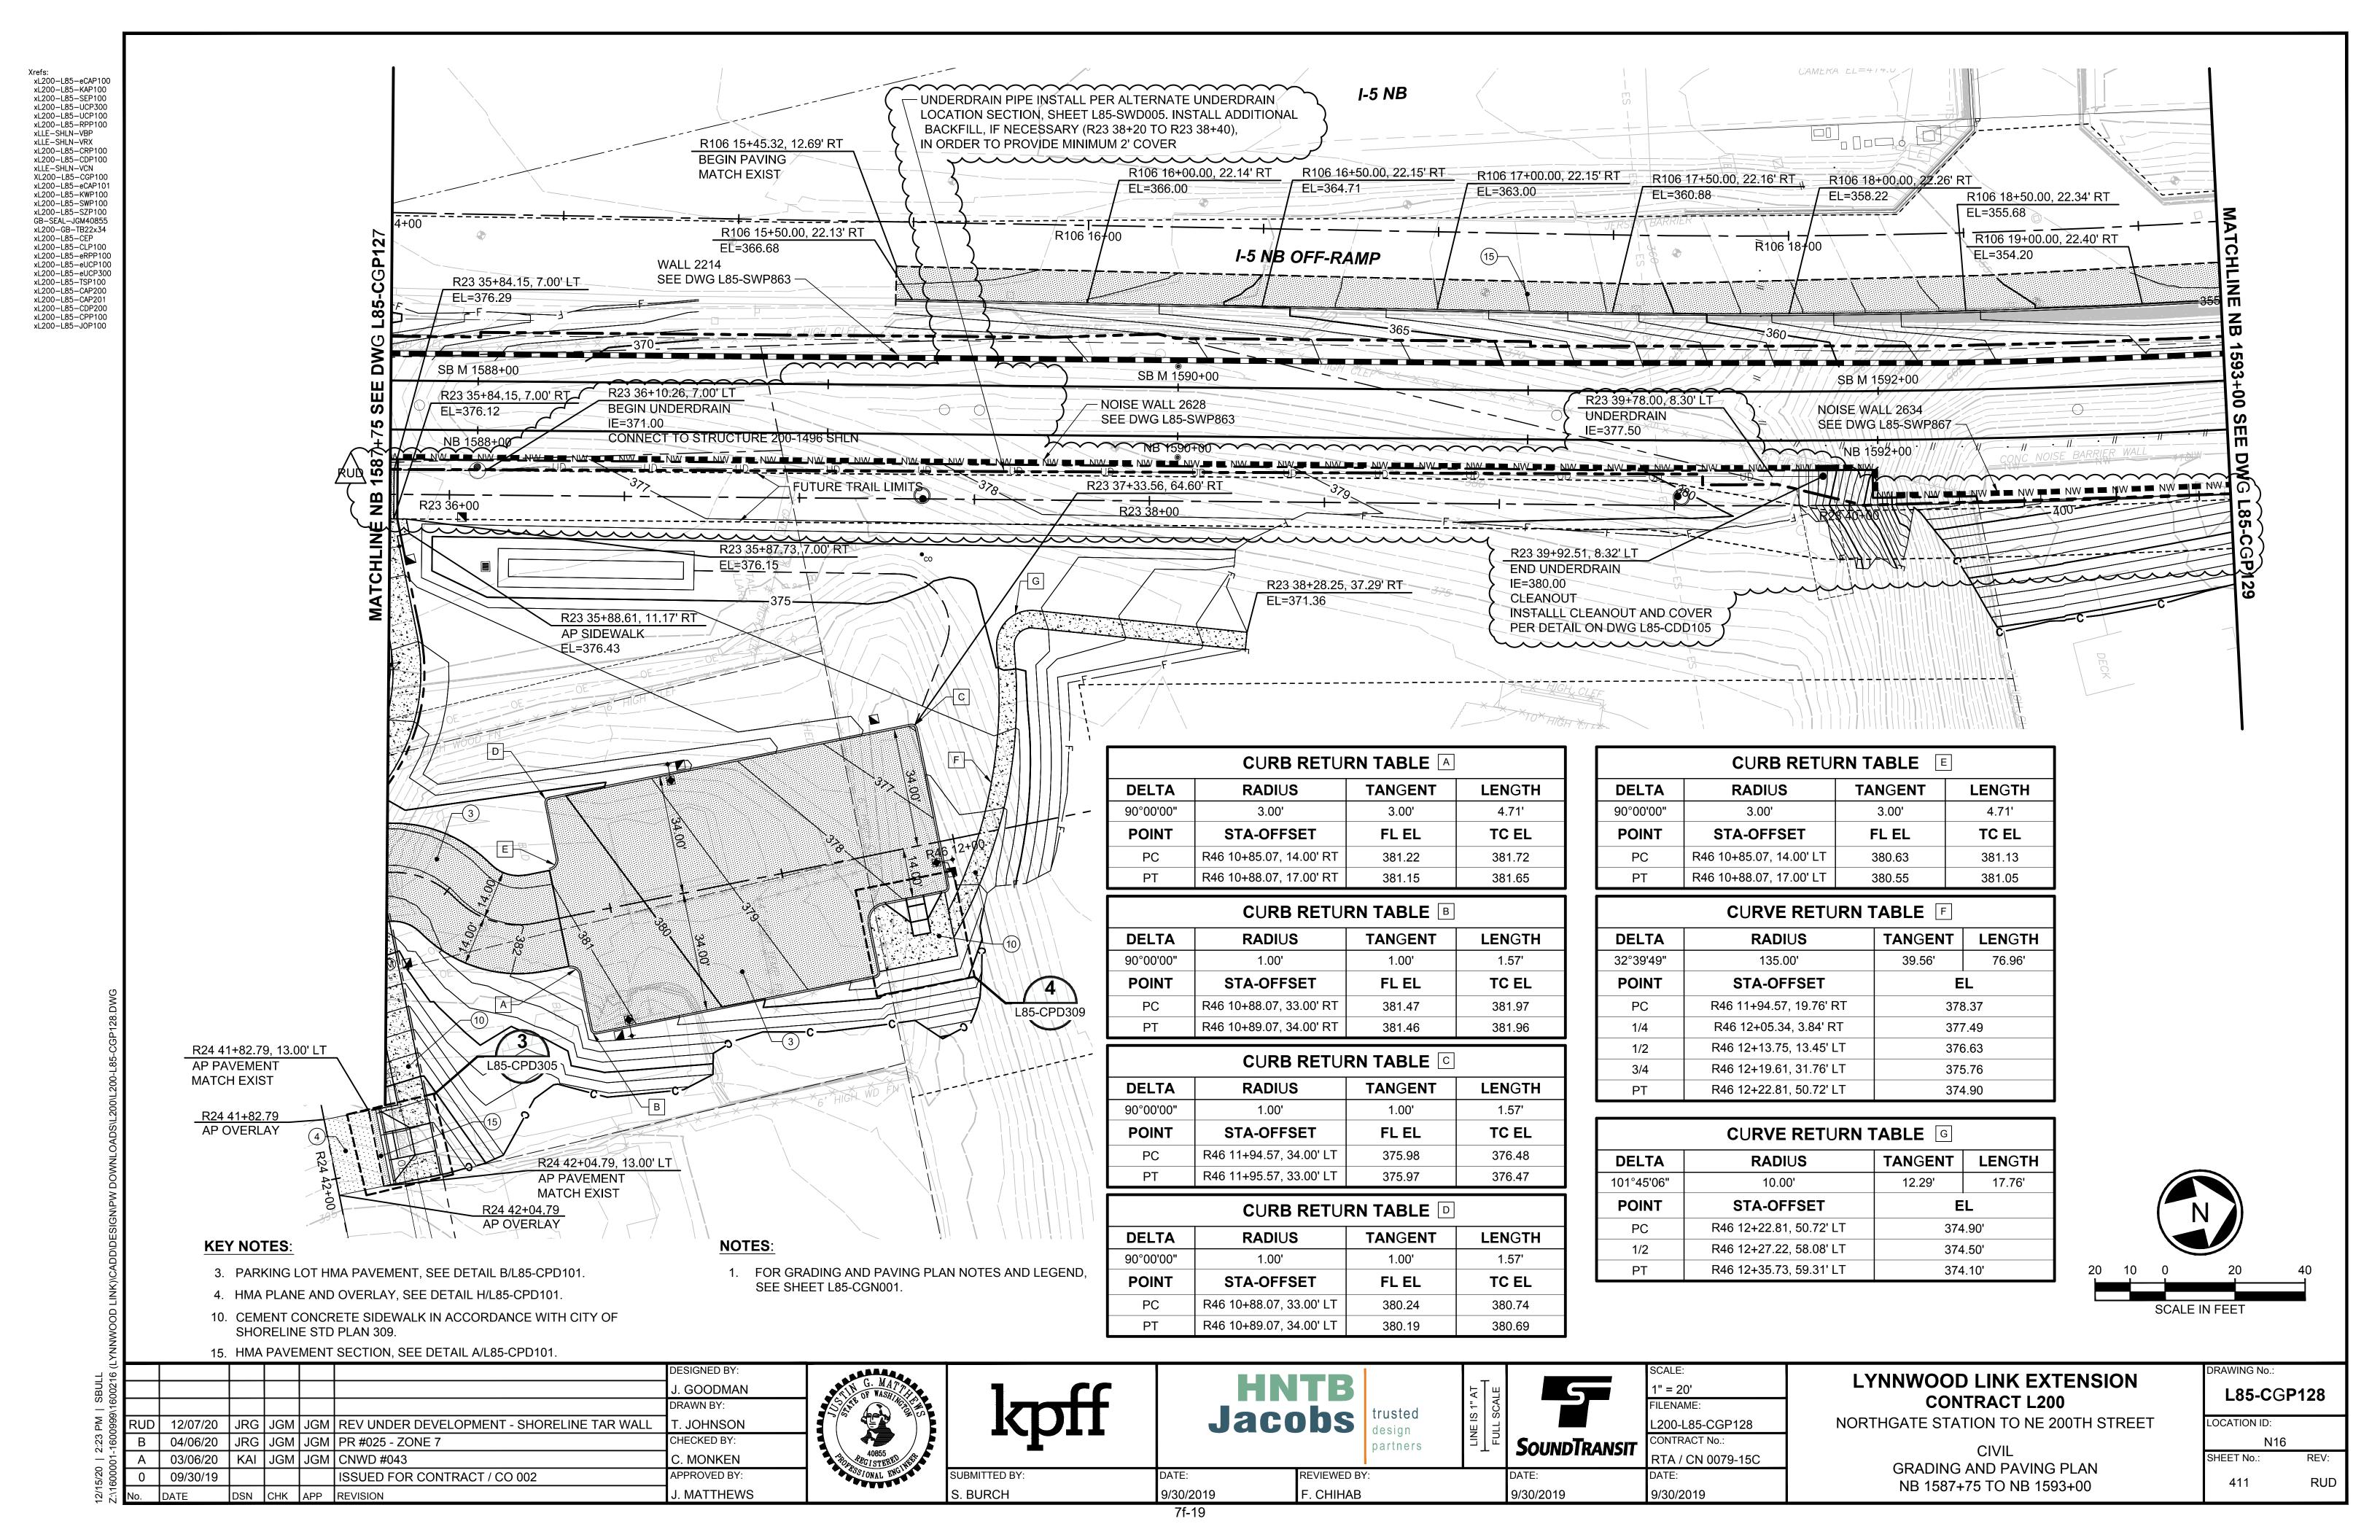

NOTES: Xrefs:
xL200-GB-TB22x34
xL200-L85-CDP100
xL200-L85-CRP100
xL200-L85-KAP100
GB-SEAL-BVE26489
xL200-L85-KWV100
xLLE-SHLN-VBP
xLLE-SHLN-VRX
xL200-L85-SWP901
xL200-L85-SWV301
xL200-L85-KWP110
xL200-L85-JOP100
xL200-L85-KWV101
xLLE-SHLN-CEP
xL200-L85-SNP100
xL200-L85-RPP100 1. SEE DRAWING L85-SWP800 FOR TYPICAL WALL PLAN AND PROFILE NOTES. 2. SEE DRAWING L85-SWP862 FOR WALL GEOMETRY SCHEDULES. SEE DWG SERIES L85-SND - WALL 2214 EXPOSED FACE CHLINE NB STA 1588+2 EE DWG L85-SWP863 SB M 1588+00 CL SB TRACK CL NB TRACK — NB 1588+00 TCI EXTENT OF WALL WALL 2623 AND 2628 EXPOSED FACE FOOTING, TYP — WALL PLAN - NB 1586+25 TO NB 1588+25 400 WALL 2214 - MSE WALL 390 TOP OF SECURITY FENCE TOP OF COPING LEGEND: TRACK ALIGNMENT GROUND IMPROVEMENT, RETAINING WALL ALIGNMENT SEE DWG SERIES L85-SND RETAINING/NOISE WALL ALIGNMENT TOP OF TRACK BALLAST — FINISH GRADE OPPOSITE TRACK M SIDE OF WALL TOP OF LEVELING PAD FILL BELOW WALL **EXISTING GRADE** SEE TRACK AND WALL UNDERDRAINS LOWER FINISHED GRADE ELEVATION 340 WHERE SHOWN UPPER FINISHED GRADE ELEVATION EXISTING GRADE ELEVATION OR FINISHED GRADE ELEVATION 330 OPPOSITE TRACK SIDE 357.43 373.45 365.51 366.21 376.03 367.49 3.4 6.90 6.50 6.50 357.02 372.92 364.98 357.77 373.97 366.05 362.52 375.61 367.05 368.60 376.24 368.05 .75 .65 .71 .73 46 59 93 02 16 88 13 14 14 .60 71 78 .25 .19 .24 82 63 16 356. 372. 364. 361. 375. 366. 364. 375. 367. 370.3 376.8 376.9 376.9 357. 373. 365. 360. 374. 366. 369. 376. 369. 361. 375. 366. 369. 376. 368. 228+00 229+54 227+54 229+00 SB WALL PROFILE - STA 227+54 TO STA 229+54 DRAWING No.: DESIGNED BY LYNNWOOD LINK EXTENSION 5 D. EVANGER L85-SWP861 **CONTRACT L200** FILENAME: Jacobs trusted NORTHGATE STATION TO NE 200TH STREET L200-L85-SWP861 LOCATION ID: CHECKED BY: N16 SoundTransit partners STRUCTURES, WALLS JS BE BE REV UNDER DEVELOPMENT - SHORELINE TAR WALL RUD 12/07/20 **B. ERICKSON** SHEET No.: RTA / CN 0079-15C PLAN, PROFILES & SCHEDULES APPROVED BY: ISSUED FOR CONTRACT / CO 002 SUBMITTED BY: REVIEWED BY 09/30/19 RUD 1580 NB 1586+25 TO NB 1588+25 SHT 1 9/30/2019 F. CHIHAB S. BURCH B. ERICKSON 9/30/2019 9/30/2019 CHK APP REVISION 7f-20

NOTES: xL200-GB-TB22x34 **NB WALL SCHEDULE** xL200-GB-TB22x34 GB-SEAL-BVE26489 xL200-L85-KWV100 xL200-L85-SWP901 xL200-L85-KWP110 xL200-L85-KAP100 xL200-L85-KWV101 xL200-L85-SWV301 1. SEE DRAWING L85-SWP800 FOR TYPICAL WALL PLAN AND PROFILE NOTES. 2. SEE DRAWING L85-SWP861 FOR WALL PLAN. **HORIZONTAL GEOMETRY** 3. | X | INDICATES EXPOSED WALL HEIGHT, H, PER CONTROL LINE CONTROL LINE OFFSET FROM WALL DRAWING L85-SWD041 **POINT** NORTH **EAST** DATA **CONTROL LINE TO** STATION COORDINATE COORDINATE WORKLINE 4. SEE DRAWING L85-SWD110 FOR FOR ACCESS WALL 1'-0 1/2" LEFT DOOR DETAILS. 627+66.00 TRANSITION 0'-0" RIGHT 5. AT CONTRACTOR'S OPTION, OMIT MSE WALL PANELS AT THIS LOCATION AND THICKEN MOMENT **VERTICAL GEOMETRY** SLAB TO ACHIEVE MINIMUM EMBEDMENT AS **BOTTOM OF WALL** SHOWN. **WALL STATION TOP OF WALL ELEVATION ELEVATION** 379.00 ACOUSTIC PANEL 367.50 NOISE WALL 627+66.00 382.00 NOISE WALL 367.50 LEFT 382.000 627+79.75 368.50 RIGHT 382.00 LEFT 627+94.00 368.50 384.00 RIGHT 368.50 LEFT 628+15.75 384.00 369.50 RIGHT 369.50 LEFT 628+51.75 384.00 370.50 RIGHT 384.00 LEFT 628+54.00 370.50 386.00 RIGHT 370.50 LEFT 628+75.75 386.00 371.50 RIGHT 371.50 LEFT 628+99.75 386.00 372.50 RIGHT 386.00 LEFT 629+14.00 372.50 388.00 RIGHT 372.50 LEFT 388.00 LEFT 629+62.00 383.00 RIGHT 375.00 RIGHT WALL 2623 - ACOUSTIC PANEL ON MSE WALL WALL 2628 - PRECAST CONCRETE NOISE WALL ON SHAFTS 2628B - CIP 400 CONCRETE WALL 400 ~~~~~ - MIN NOISE TOP OF WALL WALL HEIGHT GROUND ACCESS DOOR, 390 IMPROVEMENT, PRECAST PANEL SEE NOTE 4 -SEE DWG TOP OF JOINT, TYP SERIES L85-SND -**MOMENT** SLAB -380 14 12 12 12 LEGEND: TRACK ALIGNMENT BOTTOM OF RETAINING WALL ALIGNMENT MOMENT SLAB RETAINING/NOISE WALL ALIGNMENT TOP OF TRACK BALLAST — FINISH GRADE OPPOSITE TRACK SIDE OF WALL DRILLED SHAFT, TYP OF WALL FILL BELOW WALL **EXISTING GRADE** SEE TRACK AND WALL UNDERDRAINS 12'-0" OC SHAFT AND JOINT SPACING LOWER FINISHED GRADE ELEVATION WHERE SHOWN SEE NOTE 5 UPPER FINISHED GRADE ELEVATION EXISTING GRADE ELEVATION OR FINISHED GRADE ELEVATION OPPOSITE TRACK SIDE 365.89 376.05 376.47 362.67 375.41 375.53 .70 .67 .48 363.46 375.63 376.01 .21 .65 .77 96 22 29 29 22 26 57 .15 .46 .67 357. 372. 370. 364. 375. 376. 368. 376. 376. 358. 373. 372. 367. 376. 376. 368. 376. 376. 356. 372. 370. 357 373 371 357. 373. 371. 359. 373. 372. 368 376 376 629+00 629+63 627+63 628+00 **NB WALL PROFILE - STA 627+63 TO STA 629+63** DRAWING No.: DESIGNED BY LYNNWOOD LINK EXTENSION 5 D. EVANGER L85-SWP862 **CONTRACT L200** FILENAME: **Jacobs** trusted NORTHGATE STATION TO NE 200TH STREET H. SHI L200-L85-SWP862 LOCATION ID: RUD 12/07/20 JS BE BE REV UNDER DEVELOPMENT-SHORELINE TAR WALL CHECKED BY: N16 SoundTransit partners STRUCTURES, WALLS 01/17/20 DE BE BE PR 021 B. ERICKSON RTA / CN 0079-15C SHEET No.: PLAN, PROFILES & SCHEDULES APPROVED BY: SUBMITTED BY: ISSUED FOR CONTRACT / CO 002 **REVIEWED BY** 09/30/19 RUD 1581 NB 1586+25 TO NB 1588+25 SHT 2 S. BURCH 9/30/2019 F. CHIHAB 9/30/2019 9/30/2019 B. ERICKSON CHK APP REVISION 7f-21

NOTES: Xrefs:
xL200-GB-TB22x34
xL200-L85-CDP100
xL200-L85-CRP100
xL200-L85-KAP100
GB-SEAL-BVE26489
xL200-L85-KWV100
xLLE-SHLN-VBP
xLLE-SHLN-VRX
xL200-L85-SWP901
xL200-L85-SWV301
xL200-L85-KWP110
xL200-L85-JOP100
xL200-L85-KWV101
xLLE-SHLN-CEP
xL200-L85-SNP100
xL200-L85-RPP100 1. SEE DRAWING L85-SWP800 FOR TYPICAL WALL PLAN AND PROFILE NOTES. 2. SEE DRAWING L85-SWP864 FOR WALL GEOMETRY GROUND IMPROVEMENT, WALL 2214 EXPOSED FACE SCHEDULES. SEE DWG SERIES L85-SND SB M 1590+00 CL SB TRACK - CL NB TRACK └─ WALL 2628B **EXTENT OF WALL** WALL PLAN - NB 1588+25 TO NB 1590+25 WALL 2214 - MSE WALL GROUND IMPROVEMENT, TOP OF COPING TOP OF SECURITY FENCE - TOP OF 42" FENCE, SEE SEE DWG SERIES L85-SND SPECIFICATION SECTION 32 31 13 390 LEGEND: TRACK ALIGNMENT RETAINING WALL ALIGNMENT RETAINING/NOISE WALL ALIGNMENT └─ TOP OF LEVELING PAD TOP OF TRACK BALLAST 360 — FINISH GRADE OPPOSITE TRACK SIDE OF WALL **EXISTING GRADE** SEE TRACK AND WALL UNDERDRAINS 350 LOWER FINISHED GRADE ELEVATION WHERE SHOWN UPPER FINISHED GRADE ELEVATION EXISTING GRADE ELEVATION OR FINISHED GRADE ELEVATION 330 330 OPPOSITE TRACK SIDE 372.90 378.58 369.73 373.23 378.71 369.61 372.91 378.83 369.48 372.57 378.95 369.27 372.53 379.07 369.04 372.85 379.30 368.54 372.97 379.41 368.22 373.04 379.53 367.92 7 49 69 15 15 372.64 378.44 369.85 372.50 378.01 372. 378. 371. 377. 370. 373. 379. 379. 367. 371. 377. 370. 230+00 229+54 231+00 231+54 SB WALL PROFILE - STA 229+54 TO STA 231+54 DRAWING No.: DESIGNED BY LYNNWOOD LINK EXTENSION 5 D. EVANGER L85-SWP863 **CONTRACT L200** FILENAME: Jacobs trusted NORTHGATE STATION TO NE 200TH STREET LOCATION ID: L200-L85-SWP863 CHECKED BY: SoundTransit N16 partners STRUCTURES, WALLS JS BE BE REV UNDER DEVELOPMENT - SHORELINE TAR WALL **B. ERICKSON** SHEET No.: RUD 12/07/20 RTA / CN 0079-15C PLAN, PROFILES & SCHEDULES SUBMITTED BY: ISSUED FOR CONTRACT / CO 002 APPROVED BY: REVIEWED BY 09/30/19 RUD 1582 NB 1588+25 TO NB 1590+25 SHT 1 S. BURCH 9/30/2019 F. CHIHAB B. ERICKSON 9/30/2019 9/30/2019 CHK APP REVISION 7f-22

Xrefs: xL200-GB-TB22x34 xL200-L85-KAP100 GB-SEAL-BVE26489 xL200-L85-KWV100 xL200-L85-SWP901 xL200-L85-SWV301 xL200-L85-KWP110 xL200-L85-KWV101


NB WALL SCHEDULE VERTICAL GEOMETRY TOP OF WALL BOTTOM OF WALL WALL STATION 630+40.00 383.00 375.00


NOTES:


- 1. SEE DRAWING L85-SWP800 FOR TYPICAL WALL PLAN AND PROFILE NOTES.
- 2. SEE DRAWING L85-SWP863 FOR WALL PLAN.
- X INDICATES EXPOSED WALL HEIGHT, H, PER

DRAWING L85-SWD041.

4. NO FORMLINER REQUIRED ON EAST (NON-TRACK) SIDE OF WALL OVER STATIONS INDICATED.

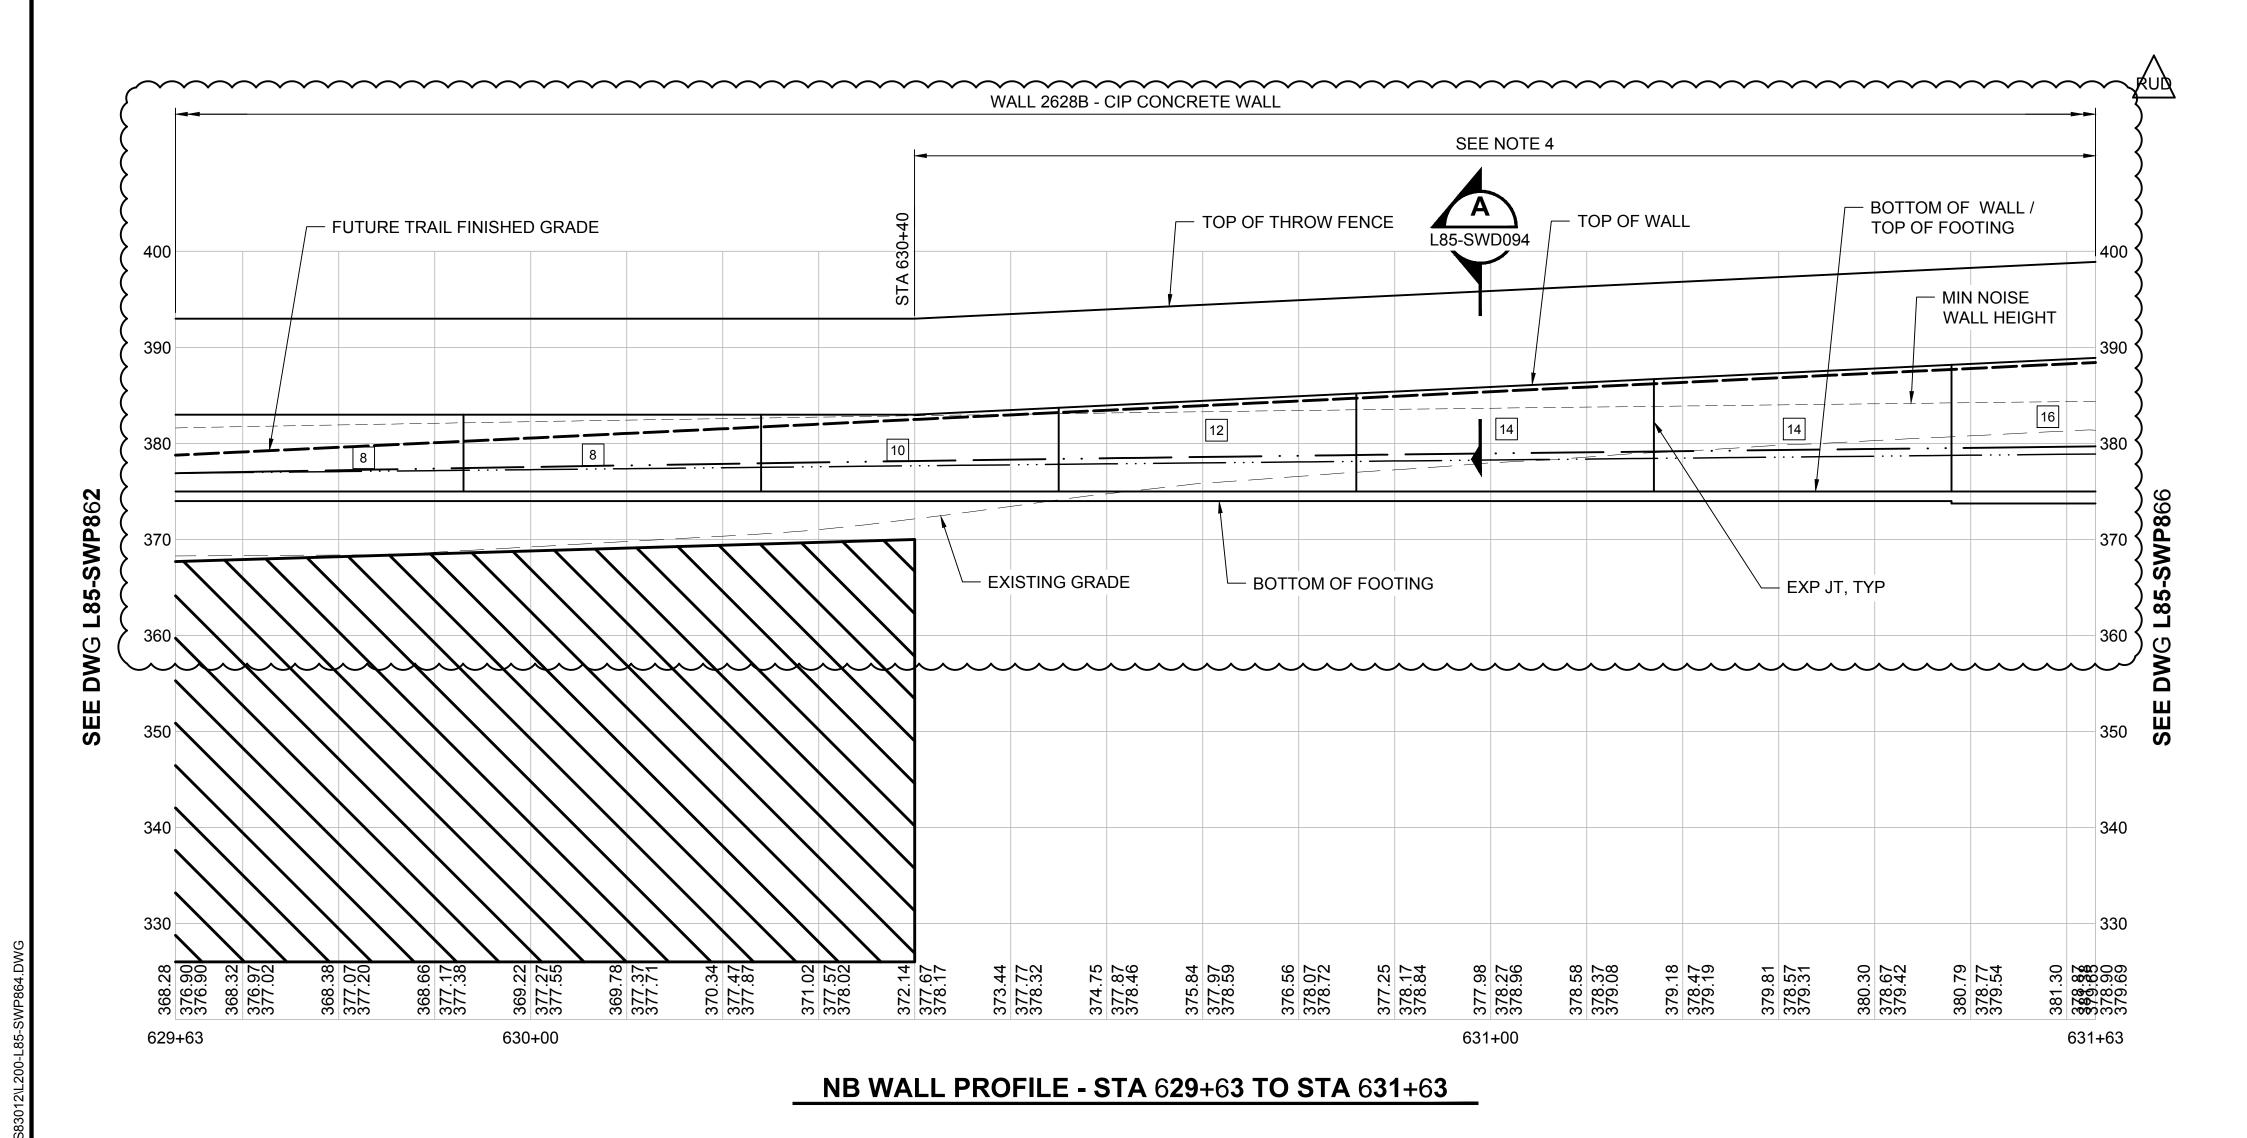

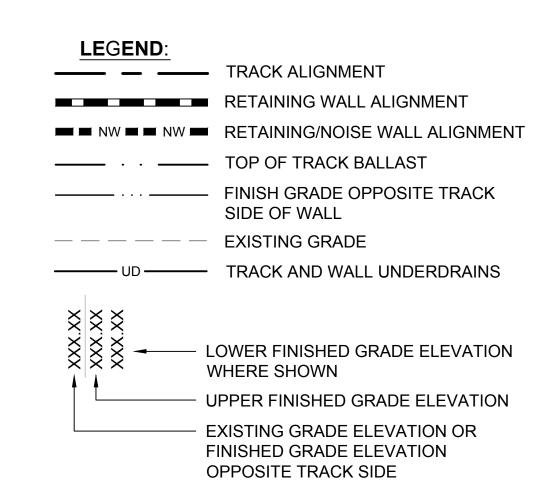

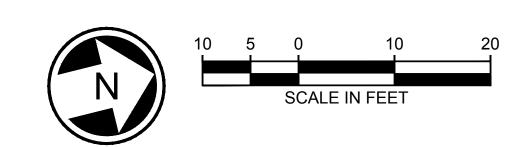

<u> </u>						
5						DESIGNED BY:
2						D. EVANGER
						DRAWN BY:
						H. SHI
Ĺ						CHECKED BY:
RUD	12/07/20	JS	BE	BE	REV UNDER DEVELOPMENT-SHORELINE TAR WALL	B. ERICKSON
0	09/30/19				ISSUED FOR CONTRACT / CO 002	APPROVED BY:
. No	DATE	DSN	СНК	APP	REVISION	B. ERICKSON



S. BURCH

kpff	
TTED BY:	DATE:



F. CHIHAB

LINE IS 1" AT	FULL SCALE	Sound
		DATE:

9/30/2019

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OUNDTRANSIT	•

	SCALE:
	1" = 10'
	FILENAME:
	L200-L85-SWP864
T	CONTRACT No.:
	RTA / CN 0079-15C
	DATE:

9/30/2019

LYNNWOOD LINK EXTENSION

CONTRACT L200 NORTHGATE STATION TO NE 200TH STREET

STRUCTURES, WALLS PLAN, PROFILES & SCHEDULES NB 1588+25 TO NB 1590+25 SHT 2

DRAWING No.:
L85-SWP864
LOCATIONUD
LOCATION ID:
N16
1110

RUD


SHEET No.:


1583

Xrefs: xL200-GB-TB22x34 xL200-L85-CDP100 xL200-L85-CRP100 xL200-L85-KAP100 GB-SEAL-BVE26489 xL200-L85-KW100 xLLE-SHLN-VBP xLLE-SHLN-VRX xL200-L85-SWP901 xL200-L85-SWV301 xL200-L85-KWP110 WALL 2214 xL200-L85-J0P100 xL200-L85-KWV101 **EXPOSED FACE** xL200-L83-RWV101 xLLE-SHLN-CEP xL200-L85-eUCP100 xL200-L85-eRPP100 STA 1591-CL SB TRACK TCHLINE NB (SEE DWG L85 CL NB TRACK - SEE NOTE 4 FOR SPLAYED TIEBACKS FOOTING, TYP - APPROX EXTENT OF TIEBACKS, SEE NOTE 3. WALL PLAN - NB 1590+25 TO NB 1591+84 410 WALL 2214 - MSE WALL TOP OF 42" FENCE, SEE TOP OF COPING SPECIFICATION SECTION 32 31 13 390 370 SEE └─ TOP OF LEVELING PAD 350 350 340 340 373.80 379.87 366.97 373.82 379.99 366.57 373.68 380.10 366.20 373.30 380.22 365.82 372.67 380.33 365.45 371.77 380.45 365.06 370.92 380.56 364.55 370.08 380.68 364.04 369.21 380.79 363.53 368.87 380.91 363.03 370.48 381.02 362.52 375.23 381.25 361.50 381.37 381.37 361.00 27 55 33 33 372.71 381.14 362.01 8 484 7 C C 373. 379. 373. 373. 367. 231+54 232+00 233+00 233+13 SB WALL PROFILE - STA 231+54 TO STA 233+13 D. EVANGER trusted

NOTES:

- 1. SEE DRAWING L85-SWP800 FOR TYPICAL WALL PLAN AND PROFILE NOTES.
- 2. SEE DRAWING L85-SWP866 FOR WALL GEOMETRY SCHEDULES.
- TIEBACK LENGTHS VARY ALONG RANGE SHOWN. APPROXIMATE LENGTH INDICATED REPRESENTS MAXIMUM LENGTH OVER THAT RANGE. LENGTHS ARE NOT DRAWN TO SCALE.
- 4. PILE 1D, 1E, AND 1F TIEBACKS TO BE SPLAYED 2 DEG HORIZONTALLY AS SHOWN TO AVOID EXISTING MANHOLE.

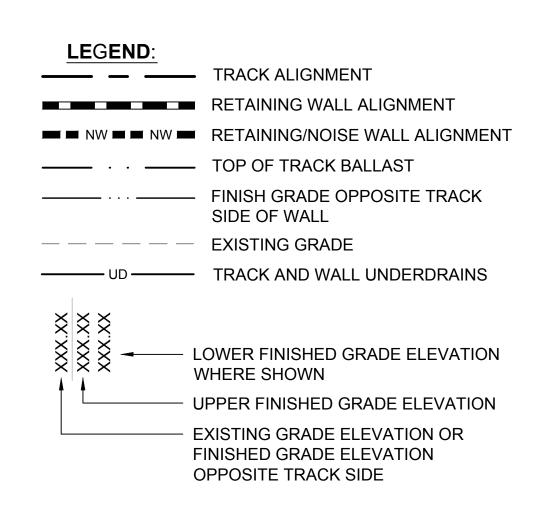

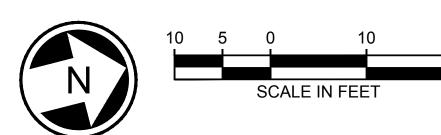

RUD 12/07/20 JS BE BE REV UNDER DEVELOPMENT - SHORELINE TAR WALL CHECKED BY: 02/19/20 DE BE BE CNWD #033 B. ERICKSON ISSUED FOR CONTRACT / CO 002 APPROVED BY: 09/30/19

CHK APP REVISION



B. ERICKSON

SUBMITTED BY:

S. BURCH

Jacobs partners

9/30/2019

7f-24

REVIEWED BY

F. CHIHAB

SoundTransit

9/30/2019

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FILENAME: L200-L85-SWP865 RTA / CN 0079-15C

9/30/2019

LYNNWOOD LINK EXTENSION **CONTRACT L200**

NORTHGATE STATION TO NE 200TH STREET


STRUCTURES, WALLS

DRAWING No.: L85-SWP865 LOCATION ID:

PLAN, PROFILES & SCHEDULES NB 1590+25 TO NB 1591+84 SHT 1


N16 SHEET No.: RUD 1584

xL200-GB-TB22x34 xL200-GB-1B22X34 xL200-L85-KAP100 GB-SEAL-BVE26489 xL200-L85-KWV100 xL200-L85-SWP901 xL200-L85-KWP110 xL200-L85-KWV101 xL200-L85-SWV301

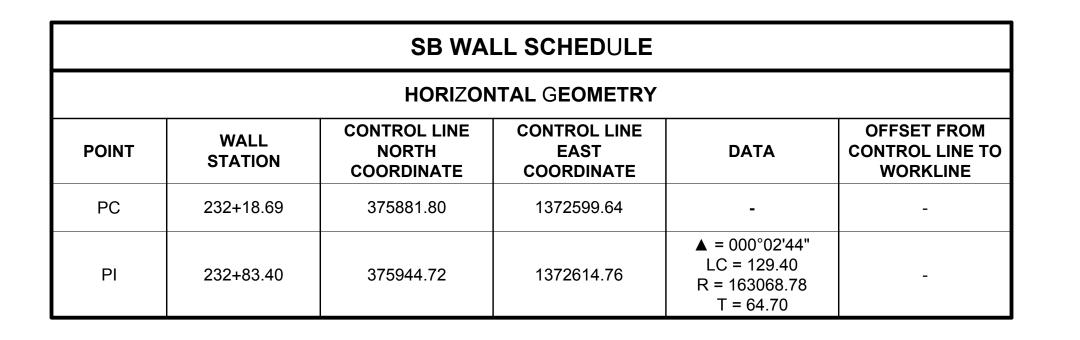

NB WALL SCHEDULE							
HORIZONTAL GEOMETRY							
POINT	WALL STATION	CONTROL LINE NORTH COORDINATE	CONTROL LINE EAST COORDINATE	DATA	OFFSET FROM CONTROL LINE TO WORKLINE		
PC	632+27.42	375874.84	1372626.76	-	-		
PI	632+74.97	375920.90	1372638.57	▲ = 001°17'39" LC = 95.10 R = 4210.03 T = 47.55	-		
PT	633+22.52	375967.22	1372649.33	-	-		
WALL TRANSITION	632+86.00	375931.68	1372640.91	-	0'-0" LEFT 0'-0" RIGHT		


VERTICAL GEOMETRY BOTTOM OF WALL TOP OF WALL WALL STATION ELEVATION ELEVATION 375.00 LEFT 631+80.00 377.00 RIGHT 377.00 LEFT 377.63 RIGHT 632+86.00 394.84

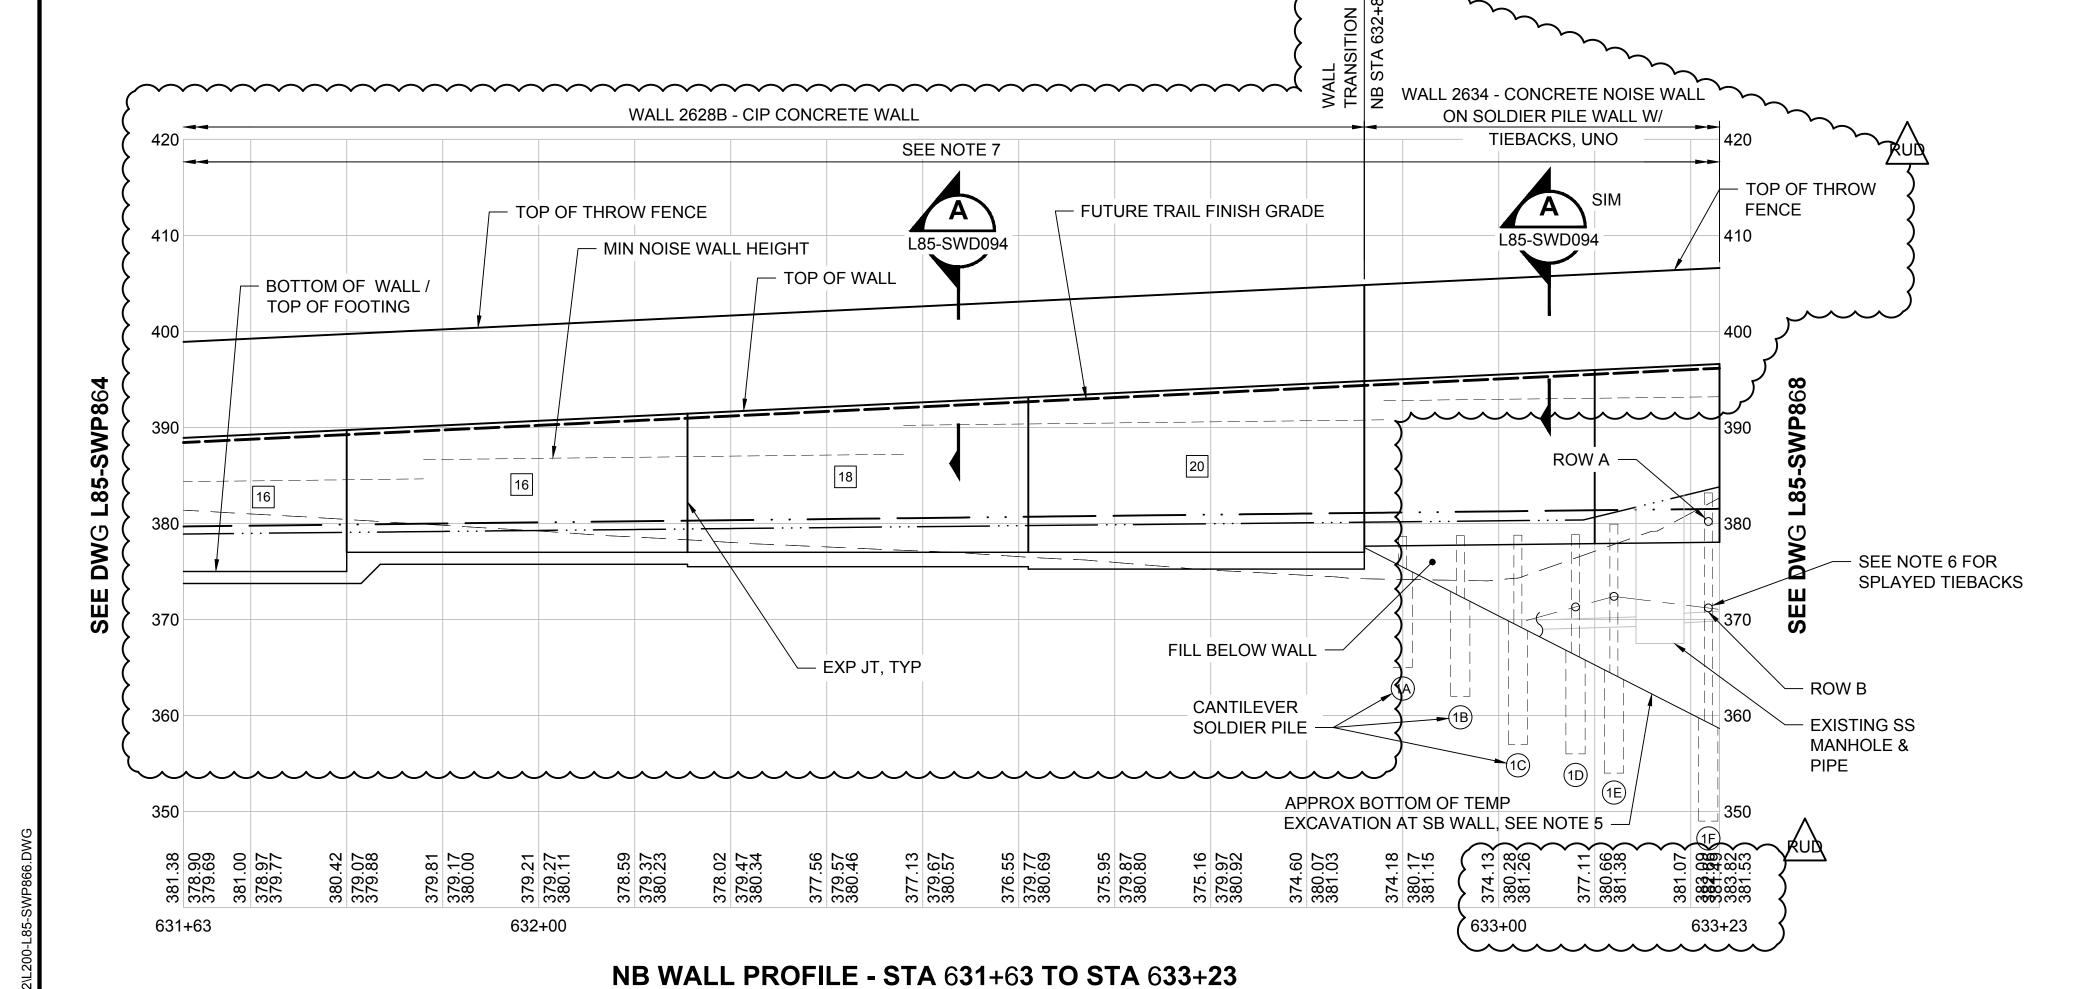

NOTES:

- 1. SEE DRAWING L85-SWP800 FOR TYPICAL WALL PLAN AND PROFILE NOTES.
- 2. SEE DRAWING L85-SWP865 FOR WALL PLAN.
- |X| INDICATES EXPOSED WALL HEIGHT, H, PER DRAWING L85-SWD041.
- 4. HORIZONTAL WALL GEOMETRY PROVIDED FOR CURVED WALL SEQUENCES DOES NOT REPRESENT TANGENCY BETWEEN ADJACENT SEGMENTS. CURVE SEGMENTS ARE NOT TANGENT TO ADJACENT SEGMENTS.
- 5. SOLDIER PILE WALL DESIGNED FOR ASSUMED DEPTH OF TEMPORARY EXCAVATION SHOWN. CONTRACTOR TO NOTIFY ENGINEER IF REQUIRED TEMPORARY EXCAVATION EXCEEDS DEPTH SHOWN ON PROFILE.
- 6. PILE 1D, 1E, AND 1F TIEBACKS TO BE SPLAYED 2 DEG HORIZONTALLY AS SHOWN ON SHEET L85-SWP865 WALL PLAN TO AVOID EXISTING MANHOLE.


NO FORMLINER REQUIRED ON EAST (NON-TRACK) SIDE OF WALL OVER STATIONS INDICATED.

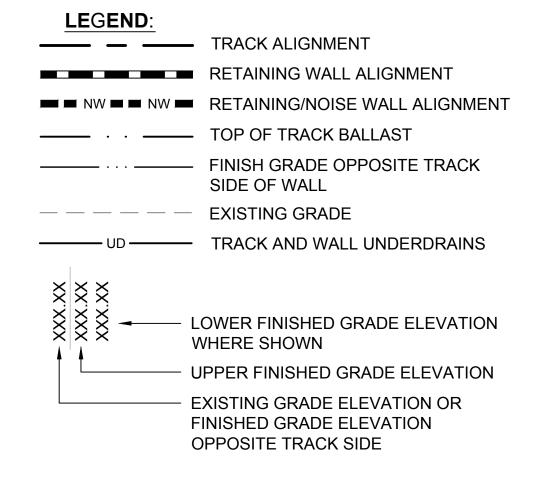





: L				-	-		
							DESIGNED BY:
							D. EVANGER
R	UD	12/07/20	JS	BE	BE	REV UNDER DEVELOPMENT-SHORELINE TAR WALL	DRAWN BY:
	С	02/19/20	DE	BE	BE	CNWD #033	H. SHI
	В	01/24/20	DE	BE	BE	PR #024	CHECKED BY:
	Α	01/17/20	DE	BE	BE	PR #021	B. ERICKSON
	0	09/30/19				ISSUED FOR CONTRACT / CO 002	APPROVED BY:
No).	DATE	DSN	CHK	APP	REVISION	B. ERICKSON

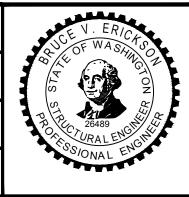

kpff	
MITTED BY:	

S. BURCH



F. CHIHAB

LINE IS 1" AT FULL SCALE	S
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SoundTrans
DATE:

9/30/2019

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OUNDTRANSIT

	SCALE:
	1" = 10'
	FILENAME:
	L200-L85-SWP866
T	CONTRACT No.:
•	RTA / CN 0079-15C

9/30/2019

10	
NAME:	
0-L85-SWP866	NORTHGAT
TRACT No.:	

CONTRACT L200 ATE STATION TO NE 200TH STREET

LYNNWOOD LINK EXTENSION

STRUCTURES, WALLS PLAN, PROFILES & SCHEDULES NB 1590+25 TO NB 1591+84 SHT 2

DRAWING No.: **L85-SWP8**66 LOCATION ID:

N16

RUD


SHEET No.: 1585

9/30/2019 7f-25

NO CHANGES TO SHEET - INCLUDED FOR REFERENCE NOTES: Xrefs: xL200-GB-TB22x34 xL200-L85-CDP100 xL200-L85-CRP100 xL200-L85-KAP100 GB-SEAL-BVE26489 SEE DRAWING L85-SWP800 FOR TYPICAL WALL PLAN AND PROFILE NOTES. 2. SEE DRAWING L85-SWP868 FOR WALL GEOMETRY xL200-L85-KWV100 xLLE-SHLN-VBP xLLE-SHLN-VRX SCHEDULES. xL200-L85-SWP901 3. TIEBACK LENGTHS VARY ALONG RANGE SHOWN. xL200-L85-SWV301 xL200-L85-KWP110 xL200-L85-JOP100 xL200-L85-KWV101 xLLE-SHLN-CEP xL200-L85-eRPP100 APPROXIMATE LENGTH INDICATED REPRESENTS MAXIMUM LENGTH OVER THAT RANGE. LENGTHS - WALL 2214 EXPOSED FACE ARE NOT DRAWN TO SCALE. 4. PILE 1G TIEBACKS TO BE SPLAYED 2 DEG HORIZONTALLY AS SHOWN TO AVOID EXISTING 59 SB M 1592+00 MANHOLE. SB M 1594+00 5. PILE 31 TIEBACKS TO BE SPLAYED 15 DEGREES HORIZONTALLY AS SHOWN TO AVOID EXISTING ် လ က MANHOLE. THE HORIZONTAL SPLAY OF PILE 22-30 NB 3 L8 TIEBACKS TO BE DECREASED LINEARLY SUCH **CL SB TRACK** TCHLINE N SEE DWG THAT MINIMUM 4 FEET DISTANCE IS PROVIDED BETWEEN ADJACENT PILE TIEBACKS. **CL NB TRACK** L85-SWD036 NB 1592+00 NB 1594+00 634+00 635+00 WALL 2634 **EXPOSED FACE** 30 **EXISTING SS** APPROX EXTENT OF PIPE TO REMAIN TIEBACK, SEE NOTE 3 SEE NOTE 4 FOR SEE NOTE 5 FOR **WALL PLAN - NB 1591+84 TO NB 1594+1**6 SPLAYED HORIZONTAL SPLAYING **TIEBACKS** OF TIEBACKS WALL 2214 - MSE WALL 410 400 - TOP OF 42" FENCE, SEE LEGEND: — TOP OF COPING **SPECIFICATION SECTION 32 31 13** TRACK ALIGNMENT RETAINING WALL ALIGNMENT RETAINING/NOISE WALL ALIGNMENT TOP OF TRACK BALLAST DWG FINISH GRADE OPPOSITE TRACK **≥** SIDE OF WALL **EXISTING GRADE** 370 W TRACK AND WALL UNDERDRAINS LOWER FINISHED GRADE ELEVATION WHERE SHOWN UPPER FINISHED GRADE ELEVATION EXISTING GRADE ELEVATION OR — TOP OF LEVELING PAD FINISHED GRADE ELEVATION 350 350 OPPOSITE TRACK SIDE 381.80 381.52 360.34 383.54 381.60 359.99 386.94 381.71 359.48 391.24 381.83 358.98 394.11 381.95 358.49 396.27 382.06 358.10 396.70 382.18 357.82 397.18 382.41 357.35 397.05 382.53 357.13 396.92 382.64 357.02 396.88 382.76 357.02 396.82 382.87 357.02 396.76 382.99 357.12 396.30 383.22 357.55 396.03 383.34 357.81 395.78 383.45 358.07 395.59 383.57 358.33 395.39 383.68 358.55 395.07 383.80 358.92 394.62 383.92 359.36 394.26 384.03 359.85 393.92 384.45 3861.37 384.18 360.53 94 95 98 54 11 29 396. 382. 357. 396. 383. 357. 233+13 234+00 235+00 235+43 SB WALL PROFILE - STA 233+13 TO STA 235+43 DRAWING No. DESIGNED BY LYNNWOOD LINK EXTENSION 5 D. EVANGER **L85-SWP8**67 **CONTRACT L200** FILENAME: Jacobs NORTHGATE STATION TO NE 200TH STREET 03/23/20 DE BE BE CNWD #043 REV 1 L200-L85-SWP867 LOCATION ID: 02/26/20 DE BE BE CNWD #043 CHECKED BY: N16 SoundTransit partners STRUCTURES, WALLS 02/19/20 DE BE BE CNWD #033 B. ERICKSON RTA / CN 0079-15C SHEET No.: PLAN, PROFILES & SCHEDULES ISSUED FOR CONTRACT / CO 002 SUBMITTED BY: APPROVED BY: **REVIEWED BY** 09/30/19 1586 NB 1591+84 TO NB 1594+16 SHT 1 9/30/2019 S. BURCH F. CHIHAB 9/30/2019 9/30/2019 B. ERICKSON CHK APP REVISION

7f-26

xL200-GB-TB22x34 xL200-L85-KAP100 GB-SEAL-BVE26489 xL200-L85-KWV100 xL200-L85-SWP901 xL200-L85-KWP110 xL200-L85-KWV101 xL200-L85-SWV301

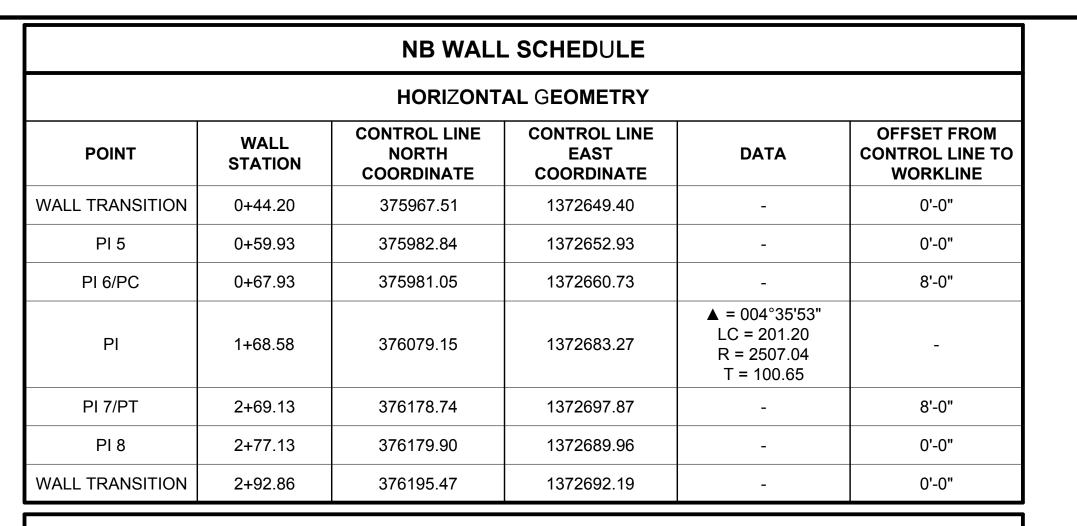

SB WALL SCHEDULE

HORIZONTAL GEOMETRY

CONTROL LINE

EAST

COORDINATE

DATA

CONTROL LINE

NORTH

COORDINATE

WALL

STATION

POINT

NB V	/ERTICAL GEOMET	RY
WALL STATION	TOP OF WALL ELEVATION	BOTTOM OF WALL ELEVATION
WALL TRANSITION / 0+44.20	396.62	-
PI 5 = 0+59.93	397.38 LEFT 407.50 RIGHT	
		-
1+01.00	407.50 LEFT 411.50 RIGHT	-
1+09.00	411.50 LEFT 415.50 RIGHT	-
1+17.00	415.50 LEFT 419.50 RIGHT	-
1+97.00	419.50 LEFT 417.50 RIGHT	-

NOTES:

- 1. SEE DRAWING L85-SWP800 FOR TYPICAL WALL PLAN AND PROFILE NOTES.
- 2. SEE DRAWING L85-SWP867 FOR WALL PLAN.
- SEE DRAWING L85-SWS107 AND L85-SWS108 FOR SOLDIER PILES, SHAFT, AND TIEBACK SCHEDULE
- 4. SOLDIER PILE WALL DESIGNED FOR ASSUMED DEPTH OF TEMPORARY EXCAVATION SHOWN. CONTRACTOR TO NOTIFY ENGINEER IF REQUIRED TEMPORARY EXCAVATION EXCEEDS DEPTH SHOWN ON PROFILE.
- 5. HORIZONTAL WALL GEOMETRY PROVIDED FOR **CURVED WALL SEQUENCES DOES NOT** REPRESENT TANGENCY BETWEEN ADJACENT SEGMENTS. CURVE SEGMENTS ARE NOT TANGENT TO ADJACENT SEGMENTS.
- 6. PILE 1G TIEBACKS TO BE SPLAYED 2 DEGREES HORIZONTALLY AS SHOWN ON SHEET L85-SWP867 WALL PLAN TO AVOID EXISTING MANHOLE.

7. PILE 31 TIEBACKS TO BE SPLAYED 15 DEGREES

HORIZONTALLY AS SHOWN ON SHEET L85-SWP867 WALL PLAN TO AVOID EXISTING MANHOLE. THE HORIZONTAL SPLAY OF PILE 22-30 TIEBACKS TO BE DECREASED LINEARLY SUCH THAT MINIMUM 4 FEET DISTANCE IS PROVIDED BETWEEN ADJACENT PILE TIEBACKS.


NO FORMLINER REQUIRED ON EAST (NON-TRACK) SIDE


PROVIDE #5 @ 9" VERTICAL NW REINF EACH FACE

FROM WALL TRANSITION TO PI 5. OF WALL OVER STATIONS INDICATED.

LEGEND: — — TRACK ALIGNMENT RETAINING WALL ALIGNMENT NW RETAINING/NOISE WALL ALIGNMENT — TOP OF TRACK BALLAST — FINISH GRADE OPPOSITE TRACK SIDE OF WALL **EXISTING GRADE** TRACK AND WALL UNDERDRAINS LOWER FINISHED GRADE ELEVATION WHERE SHOWN UPPER FINISHED GRADE ELEVATION EXISTING GRADE ELEVATION OR FINISHED GRADE ELEVATION

OPPOSITE TRACK SIDE

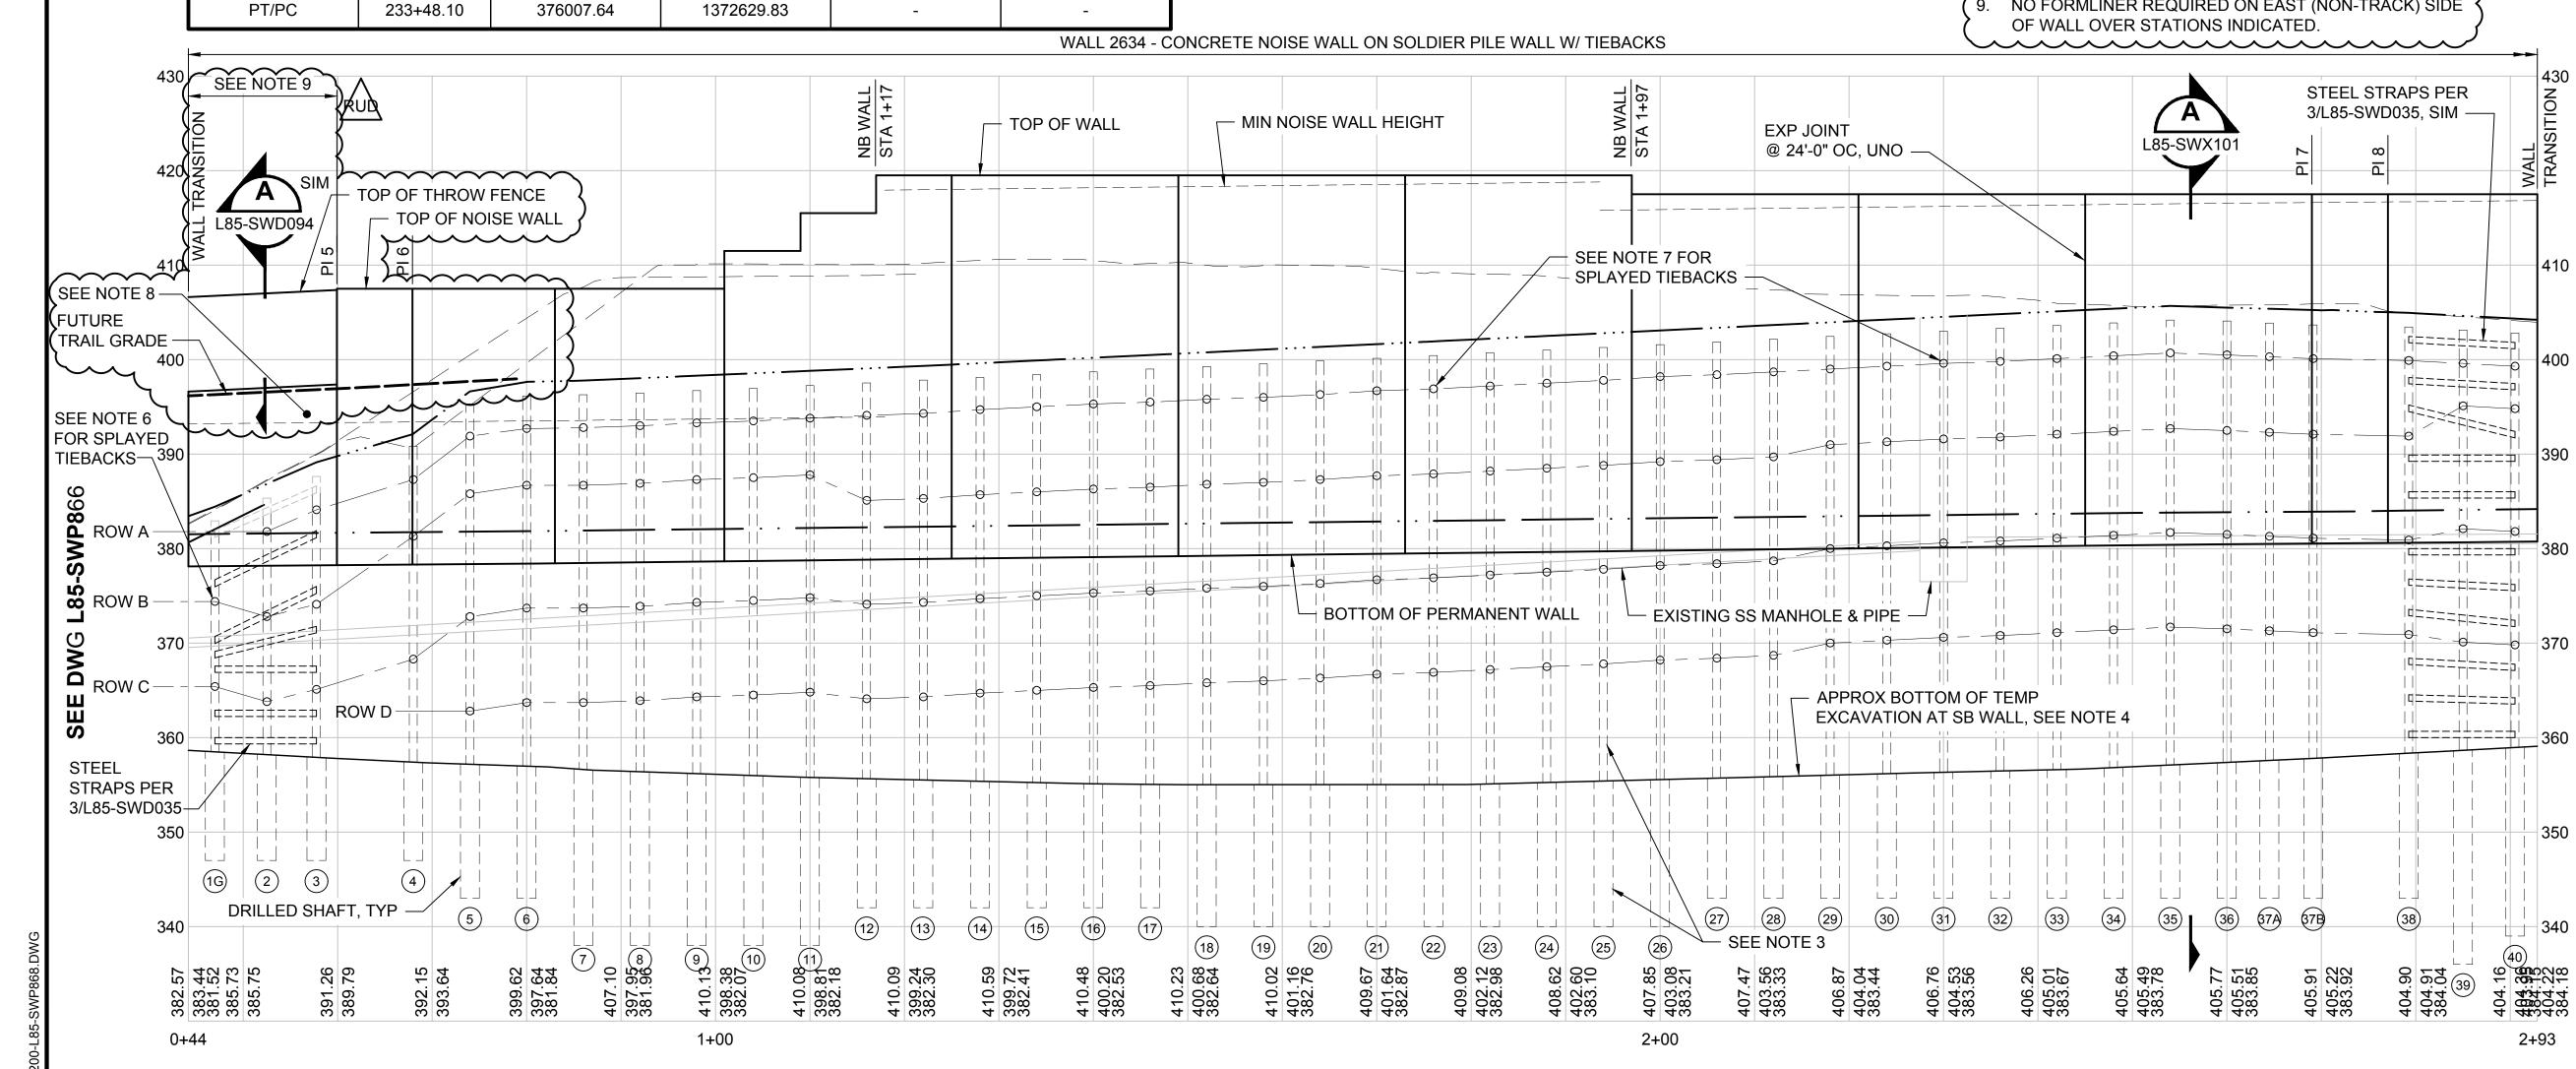

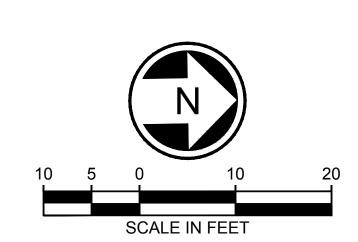

NB WALL PROFILE - STA 0+50 TO STA 2+87

D. EVANGER JS | BE | BE | REV UNDER DEVELOPMENT-SHORELINE TAR WALL DE BE BE CNWD #043 DE BE BE CNWD #033 CHECKED BY: 02/19/20 DE | BE | BE | PR #024 01/24/20 B. ERICKSON APPROVED BY ISSUED FOR CONTRACT / CO 002 09/30/19 B. ERICKSON CHK APP REVISION



OFFSET FROM

CONTROL LINE TO

WORKLINE

kpff	
SUBMITTED BY:	

S. BURCH

HNTB	
Jacobs	trusted design partners

REVIEWED BY

F. CHIHAB

LINE IS 1" AT FULL SCALE	
LINE	Soun

9/30/2019

5	
SoundTran	SI

RTA / CN 0079-15C

FILENAME: L200-L85-SWP868 CONTRACT No.

9/30/2019


CONTRACT L200 NORTHGATE STATION TO NE 200TH STREET

LYNNWOOD LINK EXTENSION

STRUCTURES, WALLS PLAN, PROFILES & SCHEDULES

DRAWING No.:
L85-SWP868
LOCATION ID:

NB 1591+84 TO NB 1594+16 SHT 2

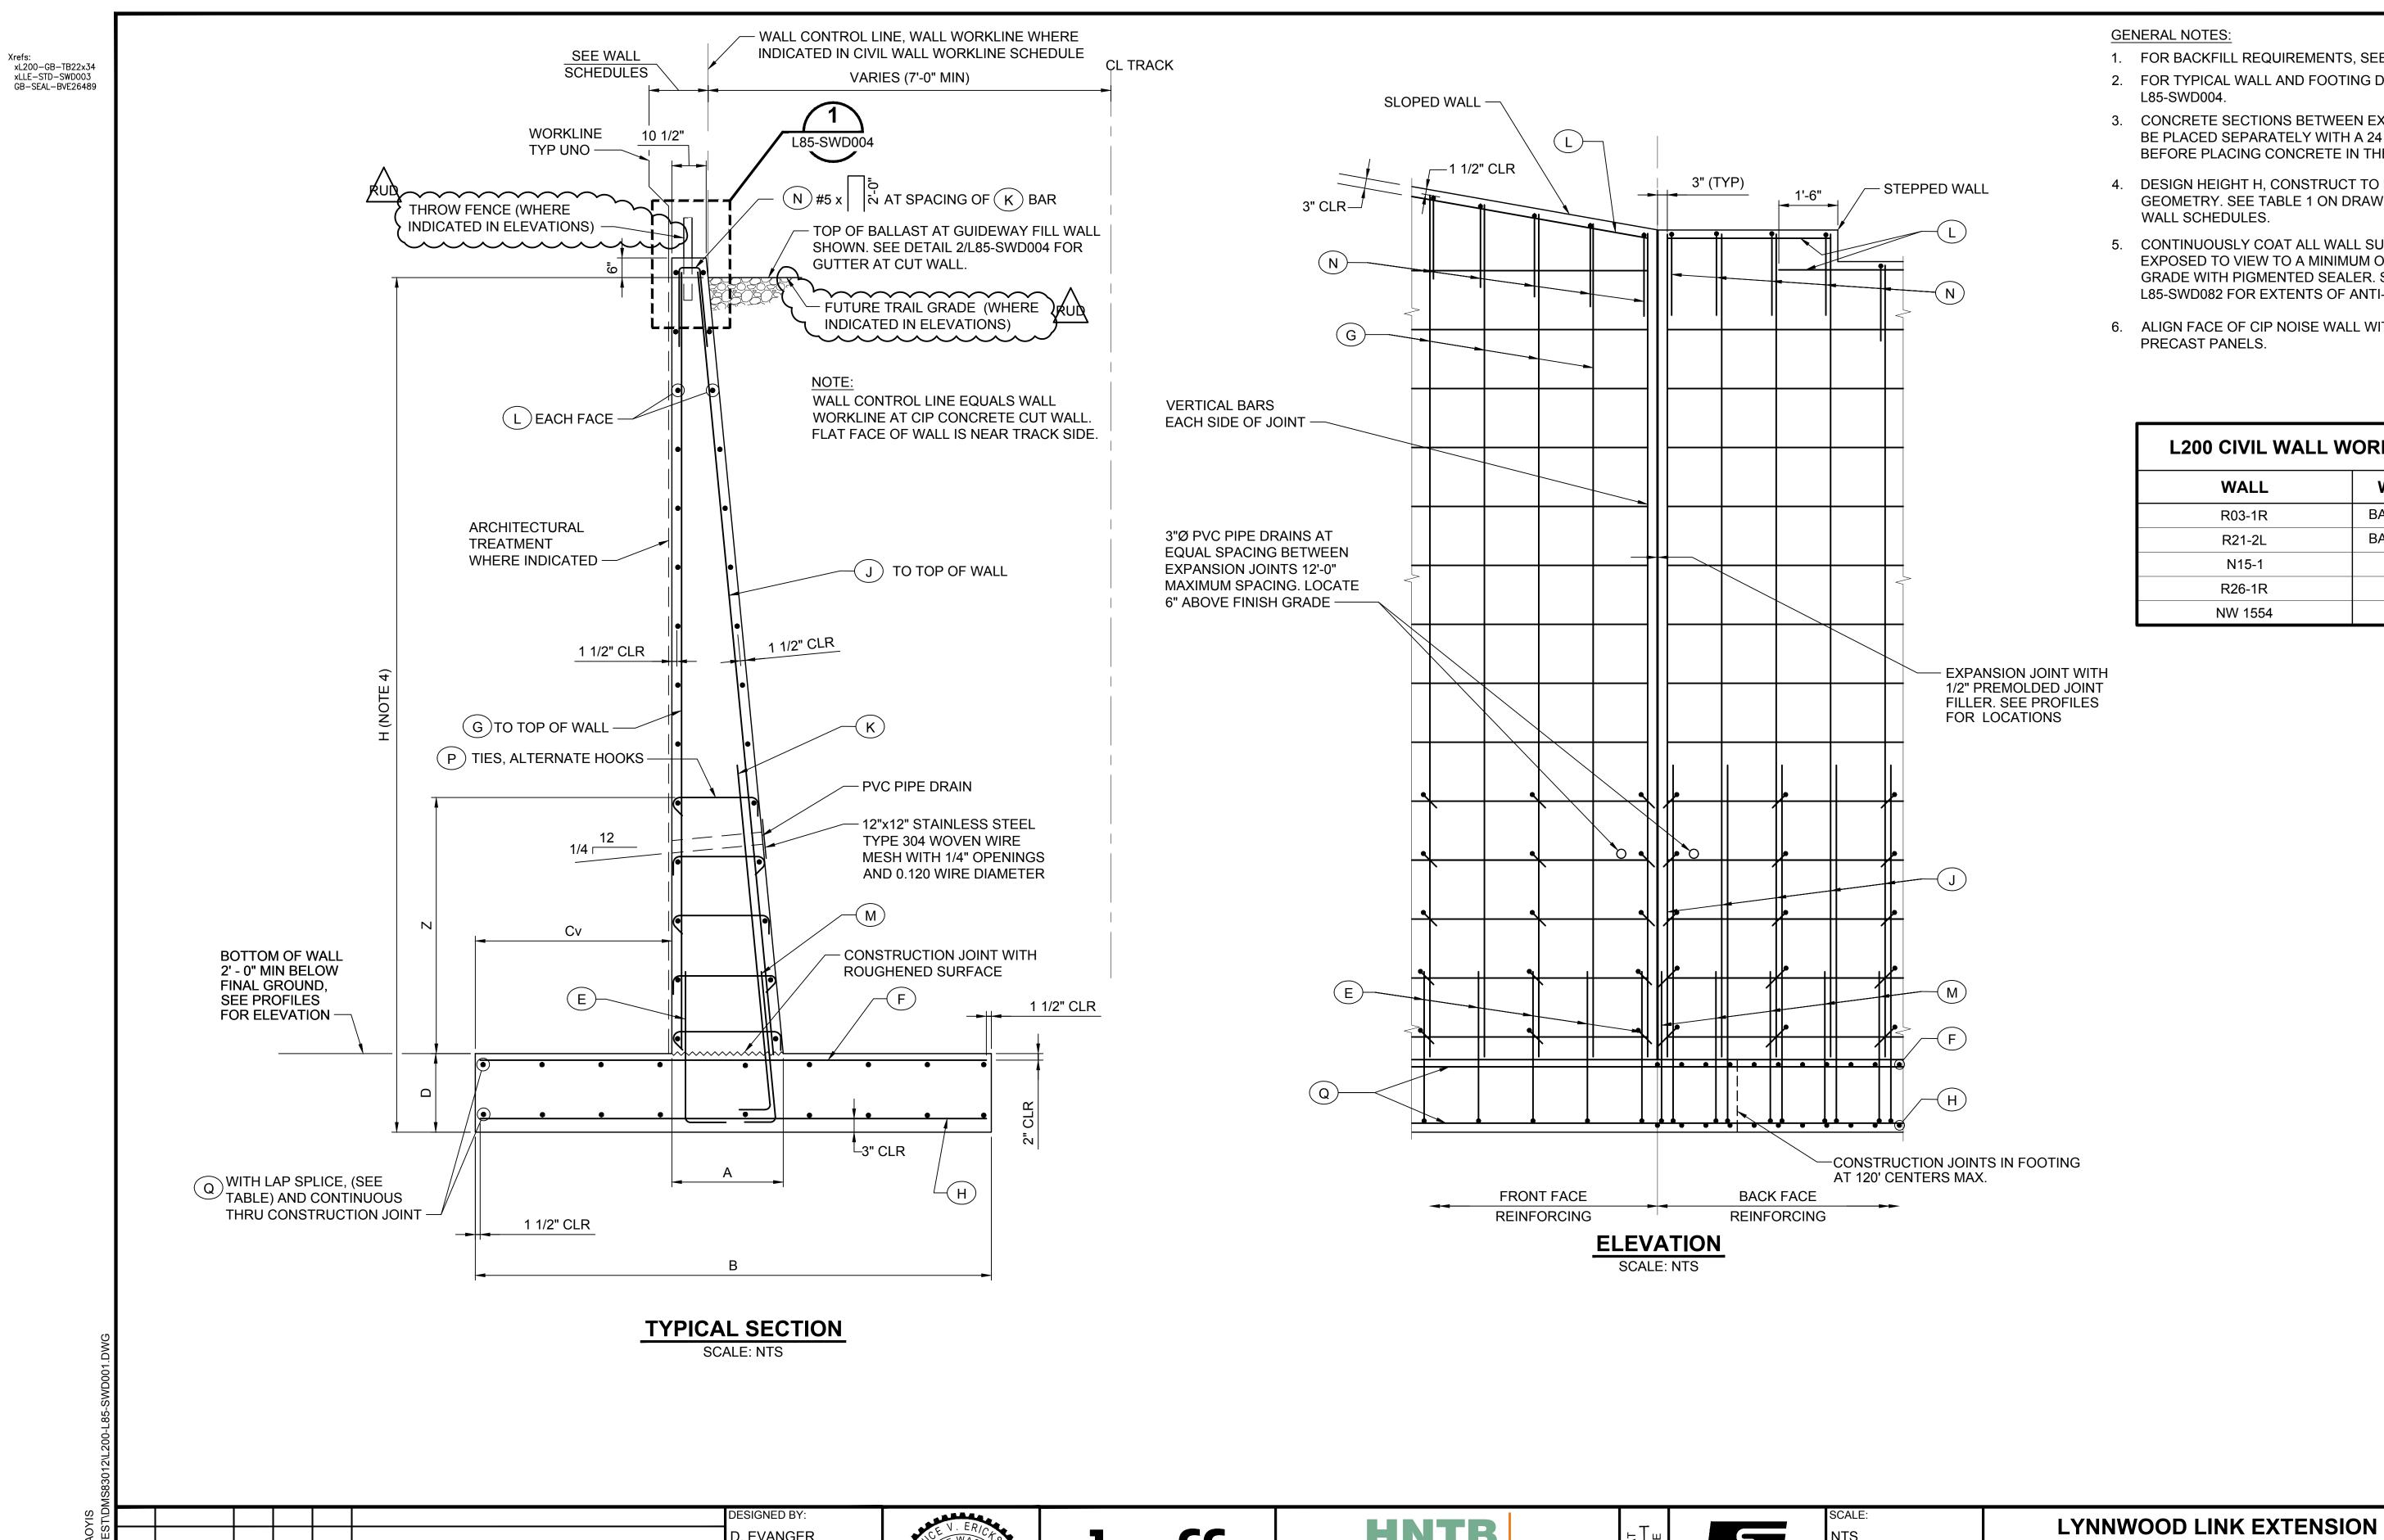

GENERAL NOTES:

- 1. FOR BACKFILL REQUIREMENTS, SEE DRAWING L85-SWD005.
- 2. FOR TYPICAL WALL AND FOOTING DETAILS SEE DRAWING L85-SWD004.
- 3. CONCRETE SECTIONS BETWEEN EXPANSION JOINTS SHALL BE PLACED SEPARATELY WITH A 24 HOUR MINIMUM PERIOD BEFORE PLACING CONCRETE IN THE ADJACENT SECTION.
- 4. DESIGN HEIGHT H, CONSTRUCT TO PROJECT PLAN GEOMETRY. SEE TABLE 1 ON DRAWING L85-SWD003 FOR WALL SCHEDULES.
- 5. CONTINUOUSLY COAT ALL WALL SURFACES PERMANENTLY EXPOSED TO VIEW TO A MINIMUM OF 1 FOOT BELOW FINAL GRADE WITH PIGMENTED SEALER. SEE DRAWING L85-SWD082 FOR EXTENTS OF ANTI-GRAFFITI COATING.
- 6. ALIGN FACE OF CIP NOISE WALL WITH FLAT FACE OF PRECAST PANELS.

L200 CIVIL WALL WORKLINE SCHEDULE					
WALL	WORKLINE LOCATION				
R03-1R	BACK FACE @ FINISH GRADE				
R21-2L	BACK FACE @ FINISH GRADE				
N15-1	FRONT FACE				
R26-1R	FRONT FACE				
NW 1554	SEE NOTE 6				

ISSUED FOR CONTRACT / CO 002

CHK APP REVISION

09/30/19

SUBMITTED BY:

S. BURCH

Jacobs trusted design partners

REVIEWED BY

F. CHIHAB

5 **SOUNDTRANSIT**

9/30/2019

FILENAME: L200-L85-SWD001 CONTRACT No.:

RTA / CN 0079-15C

9/30/2019

CONTRACT L200

NORTHGATE STATION TO NE 200TH STREET STRUCTURES, WALLS CAST-IN-PLACE CONCRETE WALLS

STANDARD DETAILS


DRAWING No.: L85-SWD001

SHEET No.: RUD 1704

LOCATION ID:

9/30/2019

DESIGNED BY D. EVANGER CHECKED BY: RUD 12/07/20 JS BE BE REV UNDER DEVELOPMENT - SHORELINE TAR WALL **B. ERICKSON** ISSUED FOR CONTRACT / CO 002 APPROVED BY: 09/30/19 B. ERICKSON CHK APP REVISION

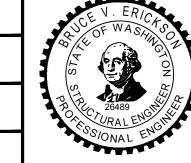

SUBMITTED BY:

S. BURCH

Jacobs trusted design partners

REVIEWED BY

F. CHIHAB

SoundTransit

9/30/2019

FILENAME: L200-L85-SWD005 RTA / CN 0079-15C

9/30/2019

LYNNWOOD LINK EXTENSION

CONTRACT L200 NORTHGATE STATION TO NE 200TH STREET STRUCTURES, WALLS


DRAWING No.: L85-SWD005 LOCATION ID:

RUD

SHEET No.:

1708

CAST-IN-PLACE CONCRETE WALLS STANDARD DETAILS

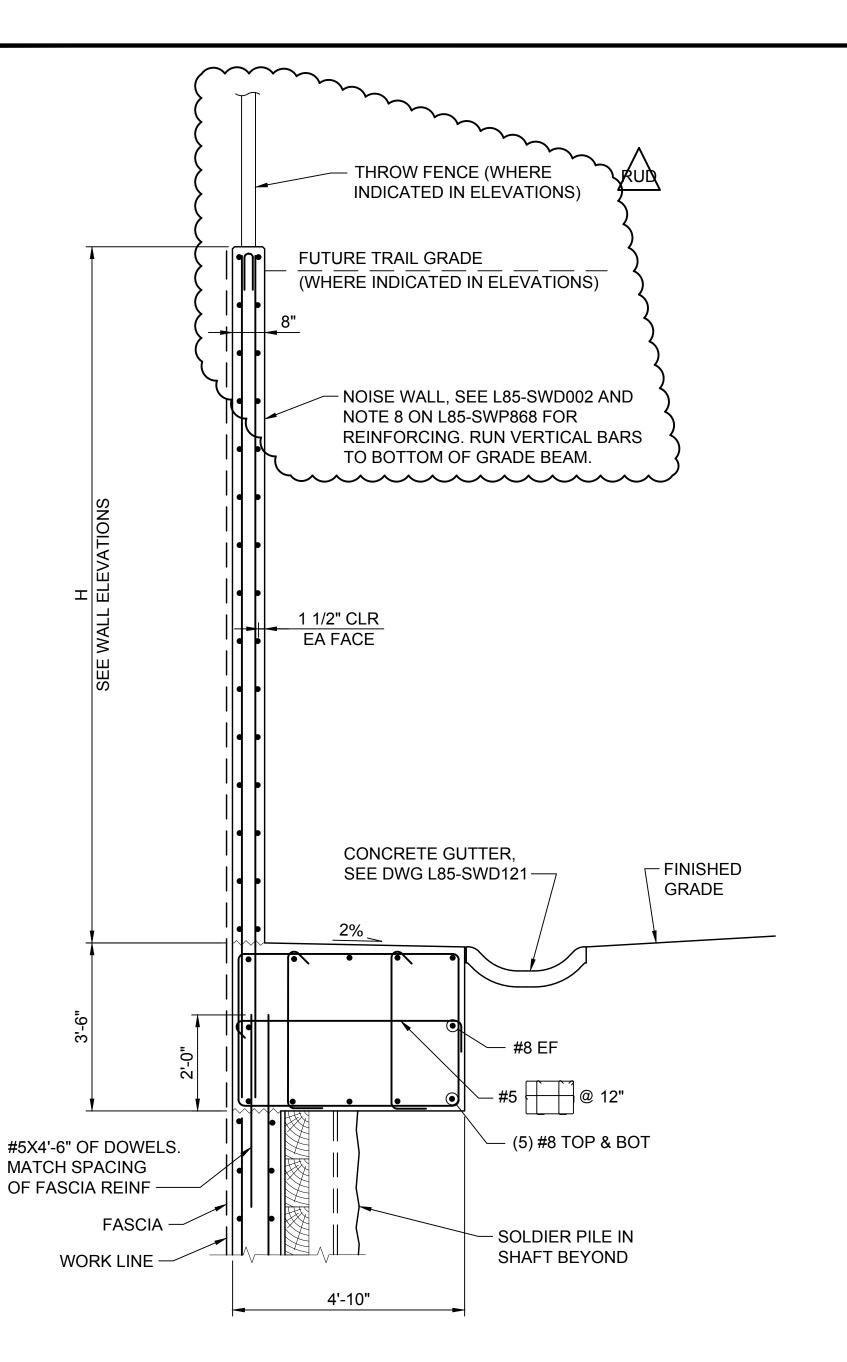


NOTES:

- 1. SEE DWG SERIES L85-CGP FOR GUTTER PLAN LOCATIONS.
- 2. SEE 2/L85-SWD034 FOR CONNECTION DETAILS AT SOLDIER PILE.




SCALE: NTS



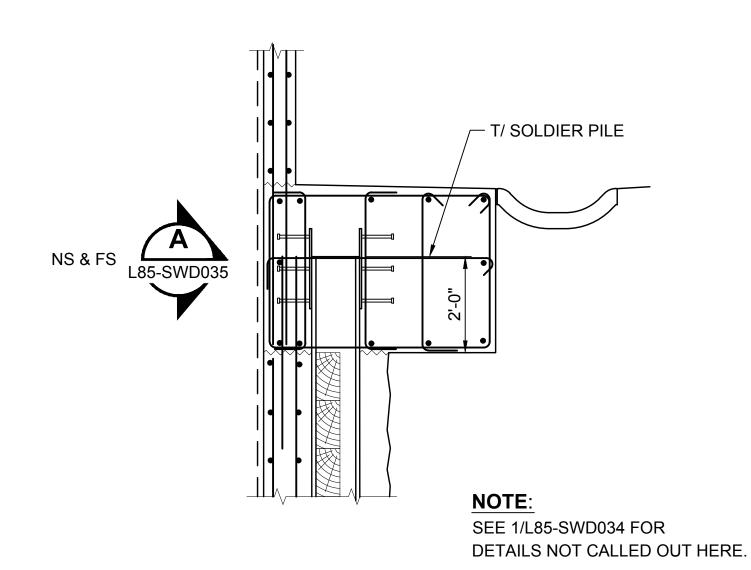

CONNECTION DETAILS AT SOLDIER PILE SCALE: NTS




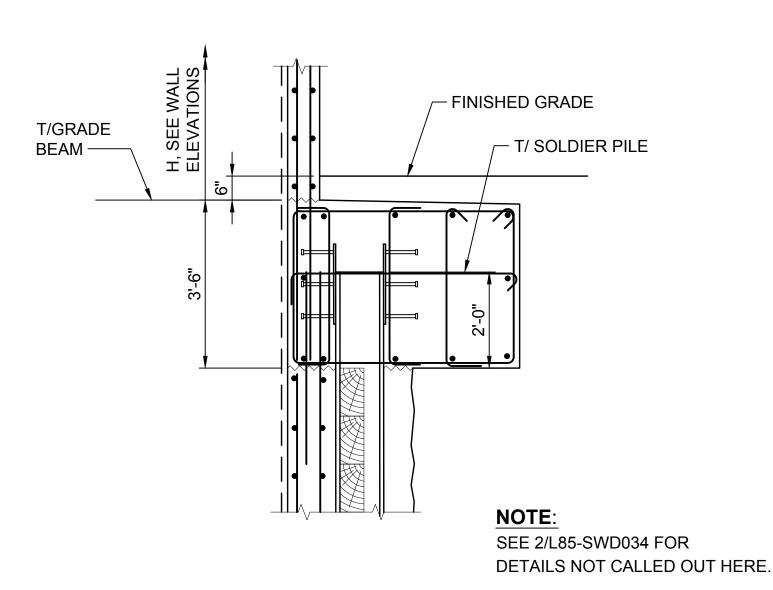

CONNECTION DETAILS AT LOWERED GRADE BEAM




L85-SWP812 L85-SWP814 L85-SWP892 L85-SWP894

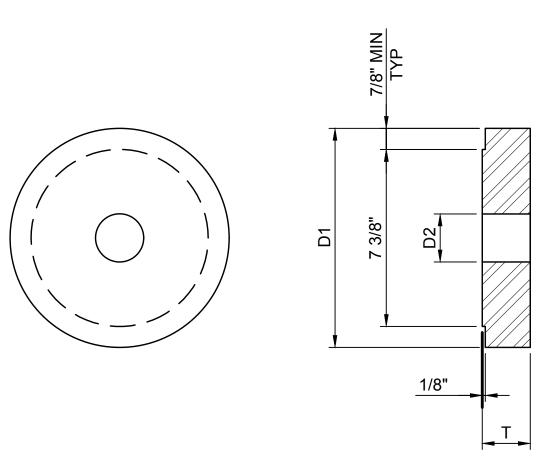

BEARING PLATE SHALL BE DESIGNED BY THE CONTRACTOR AND SUBMITTED TO THE ENGINEER FOR APPROVAL.


BEARING PLATE

SCALE: NTS

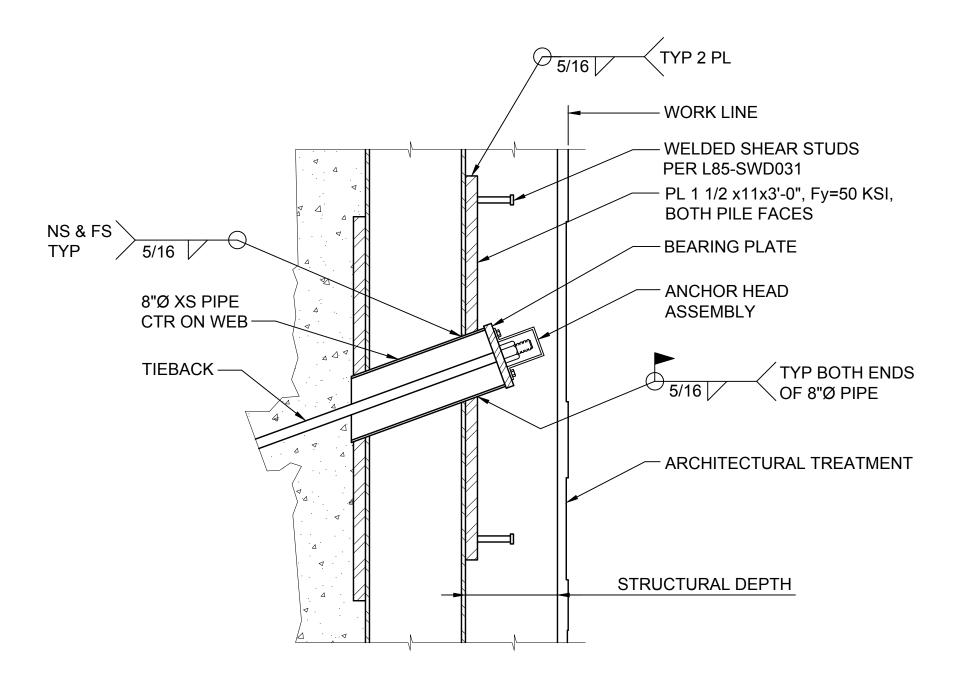

SECTION - SOLDIER PILE WITH TIEBACK ANCHOR THRU WEB

SCALE: NTS

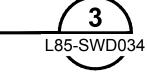

						DESIGNED BY:
						D. EVANGER
						DRAWN BY:
						H. SHI
						CHECKED BY:
RUD	12/07/20	JS	BE	BE	REV UNDER DEVELOPMENT - SHORELINE TAR WALL	B. ERICKSON
0	09/30/19				ISSUED FOR CONTRACT / CO 002	APPROVED BY:
No.	DATE	DSN	CHK	APP	REVISION	B. ERICKSON



k	pff
SLIBMITTED BV:	

S. BURCH

SCALE: NTS



REVIEWED BY

F. CHIHAB



9/30/2019

SoundTransit

FILENAME: L200-L85-SWD034 RTA / CN 0079-15C

9/30/2019

LYNNWOOD LINK EXTENSION **CONTRACT L200**

NORTHGATE STATION TO NE 200TH STREET

STRUCTURES, WALLS SOLDIER PILE/TIEBACK WALLS STANDARD DETAILS

DRAWING No.: L85-SWD034 LOCATION ID:

SHEET No.: RUD 1719

DATE:

SPACE POSTS EQUALLY, 5'-0" OC MAX, TYP **CL FENCE** NOTES: Xrefs: xL200-GB-TB22x34 GB-SEAL-BVE26489 AT NORTH END 5 1/4" 1. POSTS, RAILS AND PIPE SLEEVES SHALL BE ASTM A53 GRADE B TERMINATION OF — 1 1/2"Ø STD PIPE AND SHALL BE PAINTED IN ACCORDANCE WITH CONTRACT THROW FENCE, WRAP CL NW SEAL SPECIFICATION 09 06 00, HPC-3. COMPONENTS IDENTIFIED AS RAIL, TYP CHAINLINK FENCE LINE POST BEING GALVANIZED DO NOT REQUIRE PAINT. FABRIC BAND - END POST FABRIC AND ATTACH TO STD — TIE WIRE SPA CHAINLINK SPA AT 15" SOUTH END OF NOISE 2. CHAINLINK THROW FENCE MATERIALS AND INSTALLATION POST CAP AT 15" MAX, TYP MAX, TYP -FENCE FABRIC -SHALL CONFORM TO SPEC SECTION 32 31 33 THROW FENCE, WALL AS SHOWN — UNLESS NOTED OTHERWISE. 3. PIPE RAIL JOINT LOCATIONS SHALL BE DETERMINED BY THE CONTRACTOR. - 1 1/2"Ø STD 4. POSTS SHALL BE INSTALLED PLUMB. PIPE RAIL, TYP STRETCHER BAR, TYP **CL POST** - TRACK FACE - CL 3"Ø X-STRONG PIPE POST CHAINLINK −CL RAIL FENCE FABRIC - 1"Ø STD NO WELD PIPE SLEEVE HERE -3/16 TYP PIPE RAIL JOINT DETAIL **DETAIL** SCALE: 3" = 1'-0" SCALE: 3" = 1'-0" L85-SWD094 **FUTURE TRAIL GRADE** - KNUCKLED SELVAGE, TYP CHAINLINK FENCE FABRIC TRACK **FACE EXPANSION JOINT** - 1/8" BENT PLATE, TYP. 4 1/4" CARRIAGE BOLT TYP ÇL NW TYP AT END POSTS TYP AT LINE **TENSION BAR** - DRILL AND EPOXY 3/8" GALV THREADED ROD, 3" MIN EMBED AT SIM SECTION **INSIDE ELEVATION - THROW FENCE** SCALE: 3/4" = 1'-0" SCALE: 3/4" = 1'-0" L85-SWD094 L85-SWP864 L85-SWP866 L85-SWP868 - WALL WORKLINE FILL ANNULAR SPACE FILL ANNULAR SPACE BTWN – TOP OF WALL BTWN POST AND PIPE - TOP OF WALL POST AND PIPE SLEEVE 1 1/2" 1" SLEEVE WITH EPOXY WITH EPOXY GROUT. MOUND —(2) #4, TYP GROUT. MOUND GROUT , TYP GROUT AT TOP FOR DRAINAGE — **SECTION** AT TOP FOR DRAINAGE -2'-0" MAX SCALE: 6" = 1'-0" — PIPE SLEEVE 1'-0" MIN EMBED TOP OF - WALL REINF – WALL REINF NOT SHOWN NOT SHOWN FOR CLARITY FOR CLARITY NEW - 4"Ø GALV STD 4"Ø GALV STD PIPE SLEEVE DRAWING PIPE SLEEVE **END OF WALL** 1'-0" 1'-0" —(2) #4, TYP TYP NOTE: OTHER WALL REINFORCEMENT **DETAIL DETAIL SECTION** NOT SHOWN FOR CLARITY. SCALE: 1 1/2" = 1'-0" SCALE: 1 1/2" = 1'-0" SCALE: 1 1/2" = 1'-0" DRAWING No.: DESIGNED BY LYNNWOOD LINK EXTENSION 5 AS NOTED . STABLER L85-SWD094 **CONTRACT L200** FILENAME: Jacobs trusted design NORTHGATE STATION TO NE 200TH STREET LOCATION ID: L200-L85-SWD094 CHECKED BY: SoundTransit N16 partners STRUCTURES, WALLS RTA / CN 0079-15C SHEET No.: B. ERICKSON MISCELLANEOUS SUBMITTED BY: APPROVED BY: **REVIEWED BY** REV UNDER DEVELOPMENT - SHORELINE TAR WALL RUD 12/07/20 1743B RUD **DETAILS** 9/30/2019 S. BURCH F. CHIHAB B. ERICKSON 9/30/2019 9/30/2019 CHK APP REVISION

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Exhibit B - Retaining Wall Cost Estimate

S PRICING												
	Krebs Corporation 20-304-R2 L20 Mike Weaver	0 Shoreline 1	FAR Wall READ 2 Rev	v1	l	ESTIN	MATE SUMMAI	RY - COSTS &	& BID PRICES	l		
	Bid# Client# C Bid Description	uantity	Unit Manhours	Direct Labor	Perm Matl	Constr Mat1	Equip- Ment	Sub- Contr	Direct Total	Indirect Charge	Total Cost	Total Cost Unit Price
	1000 WALL 2628 PC NOISEWALL O	-324.00 N SHAFT	LF -366 1.13	-29,105	-190,203	-3,733	-11,231	-36,478	-270,750		-270,750	835.65
	1010 EX / BF / SET PANELS (BP-28)	-4,716.00	SF -361 0.08	-28,761	-190, 203	-3,703	-11,099		-233,766			
	1020 DRILLED SHAFTS	-230.00	LF.					-23,727	-23,727			
	1030 SH4FT REINFORCING	-6,150.00	LB -4	-344		-30	-132	-8,035	-8,541			
	1040 PIGMENTED SEALER	-4,716.00	SF					-4,716	-4,716			
	2000 WALL 2628 B CIP WALL	3,825.00	SF 3,269 0.85	268,897	85,611	135,137	120,217	119,270	729,132		729,132	190.62
	2010 EXCAVATION	707.00	CY 57 0.08	4,992		35,376	5,080		45,448			
	2020 BACKFILL	626.00	CY 134 0.21	10,597	37,289	1,964	5,463		55,313			
	2030 CIP CONC WALL FTG	129.00	CY 488 3.79	39,664	16,617	7,285	16,261	16,724	96,552			
	2040 CIP CONC WALL	231.00	CY 2,589 11.21	213,644	31,704	90,512	93,413	102,546	531,818			
	3000 WALL 2634 NOISE WALL ON S	119.00 SP WALL	SF 88 0.74	6,902	453	1,677	1,735	10,309	21,076		21,076	177.11
	4000 21% SELF PERFORM FEE	1.00	LS			81,135			81,135		81,135	81,134.97
	4100 27% SUBCONTRACT FEE	1.00	LS			25,137			25,137		25,137	25,137.12
	Totals:		2,990	246,694	-104,138	239,352	110,720	93,100	585,729	[585,729 * 585,730	

^{*} Following comparison of this Internal Cost Estimate with the cost estimate prepared by Sound Transit's L200 Contractor - SKH Joint Venture, a final price of \$590,000 was negotiated and agreed to by the City and SKH Joint Venture.

EXHIBIT C - DESIGNATED REPRESENTATIVES

Pursuant to Section I of the Agreement, the following individuals are the Parties' Designated Representatives:

SOUND TRANSIT

Barbara Hinkle

Project Manager – Lynnwood Link Ext.

Phone: (206) 370 - 5698

Email: barbara.hinkle@soundtransit.org

CITY OF SHORELINE

Tricia Juhnke, P.E.

City Engineer

Phone: (206) 801-2471

Email: tjuhnke@shorelinewa.gov